

NOTES:

1. SHOULD GROUNDWATER BE ENCOUNTERED DURING FOUNDATION OR UTILITY EXCAVATIONS, WATER SHALL BE PUMPED FROM TRENCH INTO FILTER BAGS.
2. DUE TO GRADING LIMITATIONS OF SOILS DURING WINTER MONTHS, THE CONTRACTOR SHALL NOT GRADE THESE SOILS DURING FROSTING OR ICING CONDITIONS.
3. SHOULD BEDROCK BE ENCOUNTERED DURING FOUNDATION OR UTILITY EXCAVATION, ROCK SHALL BE REMOVED AND DISPOSED OF IN A LEGAL MANNER.
4. SOIL TEST SHOULD BE PERFORMED TO DETERMINE SOIL SUITABILITY FOR TOPSOIL, IF SOIL IS DETERMINED TO BE UNSUITABLE THEN TOPSOIL SHALL BE IMPORTED AND DISTURBED THROUGHOUT THE SITE AS REQUIRED.
5. THE SUBJECT SITE DRAINS TO ITHAN CREEK WHICH DRAINS TO THE DARBY CREEK, THIS PORTION OF ITHAN CREEK WHICH HAS AN CWF/MF CHAPTER 93 CLASSIFICATION.

TYPES, DEPTH, SLOPE, LOCATIONS, AND LIMITATIONS OF THE SOILS §102.4(b)(5)(ii)

SOILS SURVEY OF DELAWARE COUNTY, PENNSYLVANIA. (NOT FIELD VERIFIED)
SOURCE OF NATURAL RESOURCES CONSERVATION SERVICE MAP. AREA DATA: VERSION 7, 11/16/2015

SYMBOL	NAME	HYDROLOGIC SOIL GROUP	SLOPES	DEPTH TO WATER TABLE	DEPTH TO RESTRICTIVE FEATURE	CONTAINS HYDRIC COMPONENTS	SURFACE RUNOFF
Md	MADE LAND, GABRRO & DABASE MATERIALS	C	0-8	>80"	>80"	NO	-



SOIL USE LIMITATIONS AND THEIR RESOLUTIONS PROVIDED

- CONTRACTOR SHALL CONSULT WITH GEOTECHNICAL ENGINEER TO DETERMINE SOIL LIMITATIONS AND RESOLUTIONS SPECIFIC TO THIS PROJECT.
1. SOIL TYPES POORLY SUITED AS SOURCES OF TOPSOIL RESTRICT OR PLACE CONDITIONS ON PLANNING VEGETATIVE STABILIZATION, ACIDIC, LOW FERTILITY, EXCESSIVE DRYNESS AND EXCESSIVE WETNESS LIMIT PLANT GROWTH. RESOLUTIONS: IDENTIFYING AND RESOLVING CHARACTERISTICS, THAT RENDER THE SOIL TYPES POORLY, SUITED AS TOPSOIL.
 2. ACIDIC SOIL TYPES EXHIBITING PH REACTION VALUES LOWER THAN ABOUT 5.5, LIMIT VEGETATIVE STABILIZATION. SOIL TESTS MIGHT BE NECESSARY TO DETERMINE SITE SPECIFIC PH REACTION. RESOLUTIONS: APPLYING LIME CONSISTENT WITH RATES DETERMINED BY SOIL TESTING; SELECTING VEGETATIVE SPECIES TOLERANT TO ACIDIC SOIL CONDITIONS; AND IMPLEMENTING COMBINATIONS OF THESE AND/OR OTHER METHODS. SPECIFIC TOLERANCE INFORMATION IS PROVIDED IN TABLE 1 OF THE EROSION CONTROL & CONSERVATION PLANTINGS ON NONCROPLAND PUBLISHED BY PENN STATE.
 3. LOW FERTILITY SOIL TYPES LACKING IN SUFFICIENT AMOUNTS OF ESSENTIAL PLANT NUTRIENTS SUCH AS: NITROGEN, PHOSPHOROUS, POTASSIUM, SULFUR, MAGNESIUM, CALCIUM, IRON, MANGANESE, BORON, CHLORINE, ZINC, COPPER AND MOLYBDENUM LIMIT VEGETATION STABILIZATION. SOIL TESTS MIGHT BE NECESSARY TO DETERMINE SITE SPECIFIC SOIL FERTILITY. RESOLUTIONS: INCORPORATING SOIL NUTRIENTS CONSISTENT WITH RATES DETERMINED BY SOIL TESTING; SELECTIVE VEGETATIVE SPECIES TOLERANT TO LOW FERTILITY SOIL CONDITIONS; AND IMPLEMENTING COMBINATIONS OF THESE AND/OR OTHER METHODS. SPECIFIC TOLERANCE INFORMATION IS PROVIDED IN TABLE 1 OF THE EROSION CONTROL & CONSERVATION PLANTINGS ON NONCROPLAND PUBLISHED BY PENN STATE.
 4. ERODIBLE SOIL TYPES EXHIBITING K VALUES GREATER THAN 0.36 OR PLASTICITY INDEX VALUES LOWER THAN 10, LIMIT VEGETATIVE STABILIZATION OF CHANNELS. RESOLUTIONS: TEMPORARY CHANNEL LINING, PROVIDING PERMANENT CHANNEL LINING, DECREASING CHANNEL GRADE, INCREASING CHANNEL WIDTH, SELECTING VEGETATIVE WITH GREATER RETARDANCE, SELECTING PERMANENT LININGS OTHER THAN GRASSES, AND IMPLEMENTING COMBINATIONS OF THESE AND/OR OTHER METHODS. VEGETATIVE RETARDANCE INFORMATION IS PROVIDED IN TABLES 6 AND 7 OF THE EROSION AND SEDIMENT POLLUTION CONTROL MANUAL PUBLISHED BY PADEP.
 5. WET SOIL TYPES HAVE EXCESSIVE ROOT ZONE AND SOIL MOISTURES. SOME SOIL SURVEYS INDICATE WETNESS, HIGH WATER TABLE AND FLOODING. THIS INDICATOR IS AFFECTED BY SOIL DISTURBANCE. RESOLUTIONS: SELECTING VEGETATIVE SPECIES TOLERANT TO WET CONDITIONS, TILING VEGETATED AREAS, AND IMPLEMENTING COMBINATIONS OF THESE AND/OR OTHER METHODS. SPECIFIC TOLERANCE INFORMATION IS PROVIDED IN TABLE 1 OF THE EROSION CONTROL & CONSERVATION PLANTINGS ON NONCROPLAND PUBLISHED BY PENN STATE.
 6. DRY SOIL TYPES LACK SUFFICIENT ROOT ZONE SOIL MOISTURES. THIS INDICATOR IS AFFECTED BY SOIL DISTURBANCE. RESOLUTIONS: SELECTING VEGETATIVE SPECIES TOLERANT TO DRY CONDITIONS, IRRIGATING VEGETATED AREAS AND IMPLEMENTING COMBINATIONS OF THESE AND/OR OTHER METHODS. SPECIFIC TOLERANCE INFORMATION IS PROVIDED IN TABLE 1 OF THE EROSION CONTROL & CONSERVATION PLANTINGS ON NONCROPLAND PUBLISHED BY PENN STATE.
 7. SOIL TYPES SUSCEPTIBLE TO SINKHOLE AND SOLUTION CHANNEL/CHAMBER FORMATION POSE LIMITATIONS ON LOCATING RESERVOIR AREAS OF SEDIMENT BASINS, SEDIMENT TRAPS, STORMWATER RETENTION BASINS, AND STORMWATER DETENTION BASINS. RESOLUTIONS: LOCATING THOSE FACILITIES ON OTHER SOIL TYPES, LINING RESERVOIR AREAS WITH IMPERMEABLE LININGS, LIMITING STANDING WATER DEPTHS, LIMITING RETENTION TIMES AND IMPLEMENTING COMBINATIONS OF THESE AND/OR OTHER METHODS.
 8. SOIL TYPES THAT EXHIBIT INSTABILITY IN POND EMBANKMENTS OR SUSCEPTIBILITY TO PIPING AND SEEPING POSE LIMITATIONS ON PLANNING EMBANKMENTS OF SEDIMENT BASINS, SEDIMENT TRAPS, STORMWATER RETENTION BASINS AND STORMWATER DETENTION BASINS. RESOLUTIONS: IMPORTING OTHER SOIL FOR EMBANKMENT OF THOSE FACILITIES, LOCATING THOSE FACILITIES ON OTHER SOIL TYPES, NOT CONSTRUCTING EMBANKMENTS DURING PERIODS PRONE TO FROST AND IMPLEMENTING COMBINATIONS OF THESE AND/OR OTHER METHODS.
 9. SOIL THAT ARE DIFFICULT TO COMPACT, UNSUITABLE FOR WINTER GRADING, OR SUSCEPTIBLE TO FROST ACTION POSE LIMITATIONS ON PLANNING EMBANKMENTS OF SEDIMENT BASINS, SEDIMENT TRAPS, STORMWATER RETENTION BASINS AND STORMWATER DETENTION BASINS. RESOLUTIONS: IMPORTING OTHER SOIL FOR EMBANKMENT OF THOSE FACILITIES, LOCATING THOSE FACILITIES ON OTHER SOIL TYPES, NOT CONSTRUCTING EMBANKMENTS DURING PERIODS PRONE TO FROST AND IMPLEMENTING COMBINATIONS OF THESE AND/OR OTHER METHODS.
 10. SUSCEPTIBILITY FOR THE DEVELOPMENT OF SINKHOLE WITHIN IDENTIFIED SOILS. RESOLUTIONS: IN THE EVENT THAT PRESENCE OF A SINKHOLE IS DETECTED DURING THE COURSE OF WORK, CORRECTIVE MEASURES SHALL BE PERFORMED UNDER THE OBSERVATION AND GUIDANCE OF THE OWNER'S GEOTECHNICAL CONSULTANT. EXCAVATE THE LOOSE, WET SOILS SURROUNDING THE SINKHOLE TO EXPOSE THE SINKHOLE "THROAT" (THE OPENING IN THE ROCK) AND THE ADJACENT STABLE SOILS/ROCK WHERE POSSIBLE. THE EXCAVATION SHALL EXTEND A MINIMUM OF TWO FEET (2') BEYOND THE STABLE SOILS OR TO THE ROCK SURFACE, WHICHEVER IS ENCOUNTERED FIRST. FILL THE EXPOSED SINKHOLE "THROAT" WITH LEAN CONCRETE TO BLOCK THE MIGRATION OF THE UPPER LAYERS OF SOIL THROUGH THE ROCK OPENING. AFTER CONCRETE HAS CURED OVERNIGHT BACKFILL THE REMAINDER OF THE EXCAVATION WITH CLAYEY SOILS TO PROVIDE A LOW PERMEABILITY BARRIER. THE CLAYEY SOILS SHALL BE PLACED IN 8" LIFTS AND EACH LIFT COMPACTED BY REPEATED PASSES OF THE COMPACTATION EQUIPMENT UNTIL STABLE. CARE SHALL BE TAKEN TO ASSURE THAT THE SOIL AT THE EDGES OF THE EXCAVATION ARE WELL COMPACTED.

DRAWING LEGEND

- PROP. LIMIT OF DISTURBANCE/NPDES BOUNDARY
- PROPOSED NPDES BOUNDARY
- PROPOSED SILT SOXX
- PROPOSED 18" SILT FENCE
- PROPOSED TREE PROTECTION FENCE
- PROPOSED CONSTRUCTION FENCE / BARRICADE
- PROPOSED TEMPORARY ROCK CONSTRUCTION ENTRANCE
- PROPOSED INLET PROTECTION
- PROPOSED SOIL RESTORATION

SOILS MAP

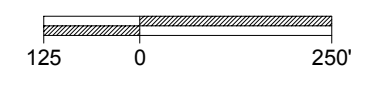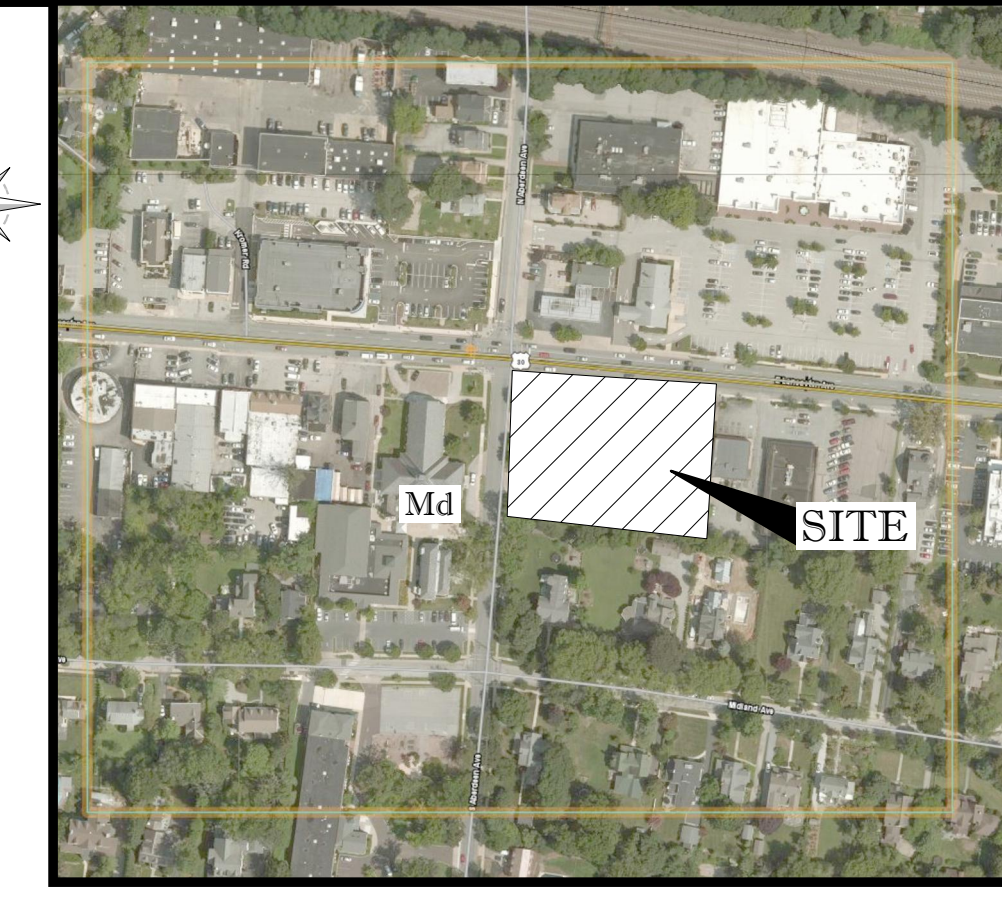

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REVISIONS

REV	DATE	COMMENT	BY
1	08/31/2018	PER DOT COMMENTS	MCM

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NOT APPROVED FOR CONSTRUCTION

PROJECT No.: PC181016
DRAWN BY: MCM
CHECKED BY: EAB
DATE: 2018.07.13
SCALE: AS NOTED
CAD ID: PC181016 SITE-1

PRELIMINARY LAND DEVELOPMENT PLANS

FOR

WAYNE PROPERTY ACQUISITION INC.

ROUTE 30 (LANCASTER AVE) & ABERDEEN AVE
RADNOR TOWNSHIP
DELAWARE COUNTY, PA

BOHLER ENGINEERING

1600 MANOR DRIVE, SUITE 200
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SHEET TITLE:

EROSION & SEDIMENTATION CONTROL PLAN

SHEET NUMBER:

10
OF 19

REVISION 1 - 2018.08.31

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