

CONSULTED DURING WINTER GRADING OPERATIONS.

ZONING DATA R-6 (RESIDENCE DISTRICT): REQUIRED EXISTING PROPOSED MINIMUM LOT SIZI *1.25 AC *1.25 AC MINIMUM LOT AREA PER UNIT 2,292 SF MAXIMUM BUILDING COVERAGE 14.5% 41.1% 70.0% MINIMUM FRONT YARD 37.8 F 63.5 FT MINIMUM SIDE YARD 20.0 FT 17.3 FT 20.0 FT MINIMUM REAR YARD 25.0 FT 6.7 FT 25.0 FT MAXIMUM IMPERVIOUS COVERAGE 63.0% 70.0% 47.4% MAXIMUM BUILDING HEIGHT 37.0± FT 39.9 FT 160.0 FT 81.2 FT 130.0 FT MAXIMUM BUILDING LENGTH MINIMUM PARKING 2.25/UNIT NA 2.27/UNIT

4. FOR MORE DETAILED INFORMATION REFER TO THE ZONING CODE OF RADNOR

19,252 SF (0.4420 AC)

LOT AREA:

DRIVES

OTHER

1. EXISTING NON-CONFORMITY LOT AREA PER UNIT BASED ON CONSOLIDATED LOT AREA. IMPERVIOUS PERCENTAGES BASED ON CONSOLIDATED SITE AREA.

TOWNSHIP, LATEST EDITION. **EXISTING LOT DATA:** TAX FOLIO NUMBER: 36-02-01219-00 TAX MAP NUMBER: 36-13-384:000 34,770 SF (0.7982 AC) SITE AREA: LOT AREA: 31,171 SF (0.7156 AC) TAX FOLIO NUMBER: 36-02-01219-01 TAX MAP NUMBER: 36-13-384: 001 SITE AREA: 19,852 SF (0.4557 AC)

CONSOLIDATED LOT DATA:

SITE AREA: 54,622 SF (1.2539 AC) LOT AREA: 50,423 SF (1.1576 AC)

EXISTING IMPERVIOUS COVERAGE: BUILDINGS & PORCHES 7,915 SF (14.5%) 726 SF PATIOS 969 SF ASPHALT DRIVES 14,168 SF 1,506 SF GRAVEL DRIVES OTHER TOTAL 25,627 SF (46.9%) PROPOSED IMPERVIOUS COVERAGE: 22,445 SF (41.1%) BUILDINGS 1,494 SF

TOTAL **GENERAL NOTES:**

DUMPSTERS OUT OF THE GARAGE.

DEVELOPMENT PLANS.

1. THESE PLANS ARE BASED ON THE NOTED REFERENCES AND THE INTENT OF THESE PLANS IS TO ILLUSTRATE A 22 UNIT MULTI-FAMILY DEVELOPMENT AS PERMITTED BY THE RADNOR TOWNSHIP R-6 ZONING DISTRICT. THE UNITS WILL BE A MIX OF 2 AND 3 BEDROOM UNITS.

10,261 SF

34,406 SF (63.0%)

2. THE MAJORITY OF THE EXISTING FEATURES WILL BE REMOVED AS SHOWN ON THE DEMOLITION PLAN.

3. THIS PROJECT WILL BE DEVELOPED AS A PLANNED COMMUNITY OR A CONDOMINIUM. 4. TRASH AND SNOW REMOVAL WILL BE THE RESPONSIBILITY OF THE HOME OWNERS ASSOCIATION. COMMON DUMPSTER AREAS ARE SHOWN ON THE PLAN. A WASTECADDY OR SIMILAR PRODUCT WILL BE USED TO WHEEL THE

5. THE RESPONSIBILITY FOR THE CONTINUED MAINTENANCE AND OPERATION OF THE STORMWATER MANAGEMENT FACILITIES WILL BE THE OBLIGATION OF THE

HOME OWNERS ASSOCIATION. 6. THE PROPERTY SHALL BE GRADED SO THAT RUNOFF FROM THE MAJORITY OF THE PROPOSED DEVELOPMENT WILL BE DIRECTED TO AND COLLECTED BY A SERIES OF INLETS AND SWALES AND CONVEYED TO THE UNDERGROUND STORMWATER MANAGEMENT SYSTEM WHICH WILL PROVIDE THE TOWNSHIP AND DEP REQUIRED RATE AND VOLUME CONTROLS. THE COLLECTED RUNOFF WILL BE OVER-CONTROLLED BY THE STORMWATER FACILITIES TO COMPENSATE FOR THE RUNOFF FROM THE REMAINING SITE AREAS THAT ARE UNCONTROLLED. OVERFLOW FROM THE PROPOSED STORMWATER MANAGEMENT FACILITIES WILL BE PIPED TO EXISTING STORM SEWER FACILITIES LOCATED IN LANCASTER AVENUE. ADDITIONAL INFORMATION WILL BE PROVIDED WITH THE FINAL LAND DEVELOPMENT PLANS.

7. THE DEVELOPMENT WILL BE SERVICED BY A NEW GRAVITY SEWER LATERAL WHICH WILL CONNECT TO THE EXISTING SEWER MAIN IN LANCASTER AVENUE. 8. THE DEVELOPMENT WILL BE SERVICED BY NEW WATER LATERAL WHICH WILL

CONNECT TO EXISTING WATER MAIN IN LANCASTER AVENUE. 9. ALL PROPOSED UTILITY LINES SHALL BE UNDERGROUND WHERE FEASIBLE. 10. LIGHTING WILL BE PROVIDED FOR THE PROPOSED PARKING AND PEDESTRIAN WALKWAYS IN ACCORDANCE WITH TOWNSHIP CODES INCLUDING 280-105.E. ADDITIONAL INFORMATION WILL BE PROVIDED WITH THE FINAL LAND

11. THE PROPOSED MONUMENT SIGN SHALL BE INSTALLED IN ACCORDANCE WITH TOWNSHIP CODES INCLUDING 280-121.C. 12. LANDSCAPING WILL BE PROVIDED IN ACCORDANCE WITH THE TOWNSHIP CODES.

ADDITIONAL INFORMATION WILL BE PROVIDED WITH THE FINAL LAND DEVELOPMENT PLANS. 13. TYPICAL EROSION AND SEDIMENTATION CONTROLS WILL BE PROVIDED FOR THE CONSTRUCTION OF THIS PROPERTY INCLUDING A STABILIZED CONSTRUCTION ENTRANCE, FILTER SOCKS, SILT FENCE, INLET PROTECTION, TOPSOIL STOCKPILES SURROUNDED BY SILT FENCE AND EROSION CONTROL MATTING, ETC. AS WELL

AS OTHER TYPICAL EROSION CONTROL MEASURES INCLUDING LIMITING SITE

DISTURBANCE, IMMEDIATE STABILIZATION, ETC. ADDITIONAL INFORMATION WILL BE PROVIDED WITH THE FINAL LAND DEVELOPMENT PLANS. 14. THE PROJECT'S RECEIVING WATERCOURSE IS ITHAN CREEK WHICH IS PART OF THE DARBY CREEK WATERSHED AND THE CHAPTER 93 CLASSIFICATION IS CWF,

369.06

15. A LOW VOLUME HIGHWAY OCCUPANCY PERMIT SHALL BE OBTAINED FROM THE PENNSYLVANIA DEPARTMENT OF TRANSPORTATION FOR ANY WORK PROPOSED WITHIN THE STATE RIGHT OF WAY.

16. AS REQUIRED BY PENNDOT, DURING CONSTRUCTION, PEDESTRIAN ACCESSIBLE ROUTES MUST BE MAINTAINED OR TEMPORARY FACILITIES PROVIDED FOR ALL EXISTING PEDESTRIAN ROUTES ALONG LANCASTER AVENUE (SR 30.) 17. THE APPLICANT SHALL PAY A FEE IN LIEU OF PROVIDING PARK AND

RECREATION LAND IN ACCORDANCE WITH 255-43.1. 18. PROPOSED WALKWAYS SLOPES SHALL NOT EXCEED 5%.

AVERAGE GRADE:

AVERAGE BUILDING GRADE CALCULATIONS: ELEV ELEV AVERAGE LENGTH 383.00 383.00 87.4 33474.20 383.00 373.80 373.80 377.00 378.40 134.1 50743.44 375.40 79.5 29844.30 377.00 383.00 380.00 135.3 51414.00 436.3 165475.9 AVERAGE GRADE: 379.27 ELEV ELEV AVERAGE LENGTH PRODUCT 371.90 372.70 371.90 365.50 368.70 140.1 51654.87 365.50 365.50 365.50 365.50 373.50 369.50 81.5 135.3 29788.25 49993.35 434.4 160320.7

LOCATION MAP SCALE: 1" = 600'

I. BOUNDARY AND TOPOGRAPHIC SURVEY PREPARED FOR RADNOR FAMILY PRACTICE BY CONTROL POINT ASSOCIATES, INC., CHALFONT, PA, DATED MAY 2,

ZONING MAP OBTAINED ELECTRONICALLY FROM THE RADNOR TOWNSHIP WEBSITE

. LIDAR TOPOGRAPHY AND OTHER GIS OBTAINED ELECTRONICALLY FROM SHAPE FILES DISTRIBUTED BY DELAWARE VALLEY REGIONAL PLANNING COMMISSION.

2014 AND LAST REVISED MAY 14, 2014. FILE NO. CP14056

FILES WERE OBTAINED VIA WWW.PASDA.PSU.EDU 4. AERIAL PHOTOGRAPH "PA_X24_Y082" & "PA_X25_Y082" PROVIDED BY DELAWARE VALLEY REGIONAL PLANNING COMMISSION AND AERIAL PHOTOMETRY

ACCESSED ELECTRONICALLY AT MAPS.GOOGLE.COM. 5. SOILS INFORMATION VIA THE NATURAL RESOURCES CONSERVATION SERVICE WEB SOIL SURVEY (WEBSOILSURVEY.SC.EGOV.USDA.GOV.)

REFERENCE PLAN #1 NOTES:

. PROPERTY KNÖWN AS FOLIO 36-02-01219-00 & 36-02-01219-01, BLOCK 61 AS IDENTIFIED ON THE TAX MAPS OF DELAWARE COUNTY, RADNOR TOWNSHIP,

- COMMONWEALTH OF PENNSYLVANIA. 2. LOCATION OF UNDERGROUND UTILITIES ARE APPROXIMATE. LOCATIONS AND SIZES ARE BASED ON UTILITY MARK-OUTS, ABOVE GROUND STRUCTURES THAT WERE VISIBLE & ACCESSIBLE IN THE FIELD, AND THE MAPS AS LISTED IN THE REFERENCES AVAILABLE AT THE TIME OF THE SURVEY. AVAILABLE AS-BUILT PLANS AND UTILITY MARKOUT DOES NOT ENSURE MAPPING OF ALL UNDERGROUND UTILITIES AND STRUCTURES. BEFORE ANY EXCAVATION IS TO BEGIN, ALL UNDERGROUND UTILITIES SHOULD BE VERIFIED AS TO THEIR LOCATION, SIZE AND TYPE BY THE PROPER UTILITY COMPANIES. CONTROL
- ALL SUCH UTILITIES IN THE AREA EITHER IN SERVICE OR ABANDONED. 3. THIS PLAN IS BASED ON INFORMATION PROVIDED BY A SURVEY PREPARED IN THE FIELD BY CONTROL POINT ASSOCIATES, INC. AND OTHER REFERENCE MATERIAL AS LISTED HEREON.

POINT ASSOCIATES, INC. DOES NOT GUARANTEE THE UTILITIES SHOWN COMPRISE

- 4. THIS SURVEY WAS PREPARED WITHOUT THE BENEFIT OF A TITLE REPORT AND IS SUBJECT TO THE RESTRICTIONS, COVENANTS AND/OR EASEMENTS THAT MAY BE CONTAINED THEREIN.
- 5. BY GRAPHIC PLOTTING ONLY PROPERTY IS LOCATED IN FLOOD HAZARD ZONE > (AREAS DETERMINED TO BE OUTSIDE THE 0.2% ANNUAL CHANCE FLOODPLAIN) PER REF. MAP NUMBER 42045C0017F AND 42045C0036F. MAP REVISED 6. THE EXISTENCE OF UNDERGROUND STORAGE TANKS, IF ANY, WAS NOT KNOWN
- AT THE TIME OF THE FIELD SURVEY. 7. ELEVATIONS ARE BASED UPON PA DOT BENCHMARK F101 REPUTED TO BE NAVD 1988 ELEVATION 343.57
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- CONSULTANT PRIOR TO CONSTRUCTION. 9. THESE UNDERGROUND UTILITY COMPANIES DID NOT RESPOND TO PA ONE CALL REQUEST: ELECTRIC, GAS, AND TELEPHONE.

REFERENCE PLAN #1 REFERENCES: 1. MAP #015 OF THE OFFICIAL TAX MAPS OF THE RADNOR TOWNSHIP, DELAWARE

COUNTY, COMMONWEALTH OF PENNSYLVANIA. 2. MAP ENTITLED "NATIONAL FLOOD INSURANCE PROGRAM, FIRM, FLOOD INSURANCE RATE MAP, PENNSYLVANIA, DELAWARE COUNTY, PANEL 36 OF 250",

COMMUNITY-PANEL NUMBER 420428 0036 F, MAP REVISED: NOV 18, 2009. . MAP ENTITLED "NATIONAL FLOOD INSURANCE PROGRAM, FIRM, FLOOD INSURANCE RATE MAP. PENNSYLVANIA. DELAWARE COUNTY. PANEL 17 OF 250".

COMMUNITY-PANEL NUMBER 420428 0017 F, MAP REVISED: NOV 18, 2009.

- 4. MAP ENTITLED "COMMONWEALTH OF PENNSYLVANIA. DEPARTMENT OF HIGHWAYS. DRAWING FOR CONSTRUCTION AND CONDEMNATION OF RIGHT OF WAY ROUTE NO. 142 SECTION NO. 1 IN DELAWARE COUNTY; FROM STA. 2882+35 TO STA. 2891+10, LENGTH 875.0 FT 0.166 MI," SHEETS 1-3. 5. MAP ENTITLED "AS BUILT SURVEY MADE FOR J. GORDON AND LOIS T.
- LONGENECKER, RADNOR TOWNSHIP, DELAWARE COUNTY, PENNSYLVANIA," PREPARED BY YERKS ASSOCIATES, INC.,. DATE MARCH 28, 2002.PLAN D-36-13 384.

RECORD OWNER: EQUITABLE OWNER: WALKER FAMILY PROPERTIES. LLP 427 LANCASTER AVE, LLC 44 PAPER MILL ROAD 427 EAST LANCASTER AVENUE WAYNE, PA 19087 NEWTOWN SQUARE, PA 19073

COMMONWEALTH OF PENNSYLVANIA

COUNTY OF _____

ON THIS THE __ DAY OF 20__, BEFORE ME, THE UNDERSIGNED PERSONALLY APPEARED DAVID SCOTT BREHMAN, MEMBER OF 427 E. LANCASTER, LLC, WHO BEING DULY SWORN ACCORDING TO LAW DEPOSES AND SAYS THAT 427 E. LANCASTER, LLC IS THE EQUITABLE OWNER OF THE PROPERTY SHOWN ON THIS PLAN, THAT THE LAND DEVELOPMENT PLAN WAS MADE AT HIS DISCRETION AS SUCH MEMBER AND THAT HE ACKNOWLEDGES THE SAME TO BE THE ACT AND PLAN OF 427 E. LANCASTER, LLC AND DESIRES THE SAME TO BE RECORDED AS SUCH ACCORDING TO LAW.


427 E. LANCASTER, LLC

DAVID SCOTT BREHMAN TITLE: MEMBER

WITNESS MY HAND AND SEAL THE DAY AND YEAR AFORESAID.

NOTARY SIGNATURE

MY COMMISSION EXPIRES:

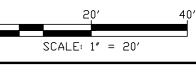

PROPOSED MULTI-FAMILY RESIDENTIAL DEVELOPMENT 427 EAST LANCASTER AVENUE, WAYNE, PA 19087 RADNOR TOWNSHIP DELAWARE COUNTY PRELIMINARY PLANS

1 02/22/16 PER TWP ENGS DATE COMMENTS

PROFESSIONAL

CHRISTOPHER C. YOH

ILLUSTRATIVE SITE PLAN EQUITABLE OWNER/APPLICANT 427 E. LANCASTER, LLC 44 PAPER MILL ROAD

NEWTOWN SQUARE, PA 19073


DATE: SCALE: ONE CALL NUMBER: DRAWN BY: PROJECT NUMBER:


DECEMBER 31, 2015 '' = 20'2016-011-1937 CCY 15-031

OF

YOHN ENGINEERING, LLC 555 SECOND AVENUE, SUITE G-110 COLLEGEVILLE, PA 19426 610-489-4580 WWW.YOHNENGINEERING.COM



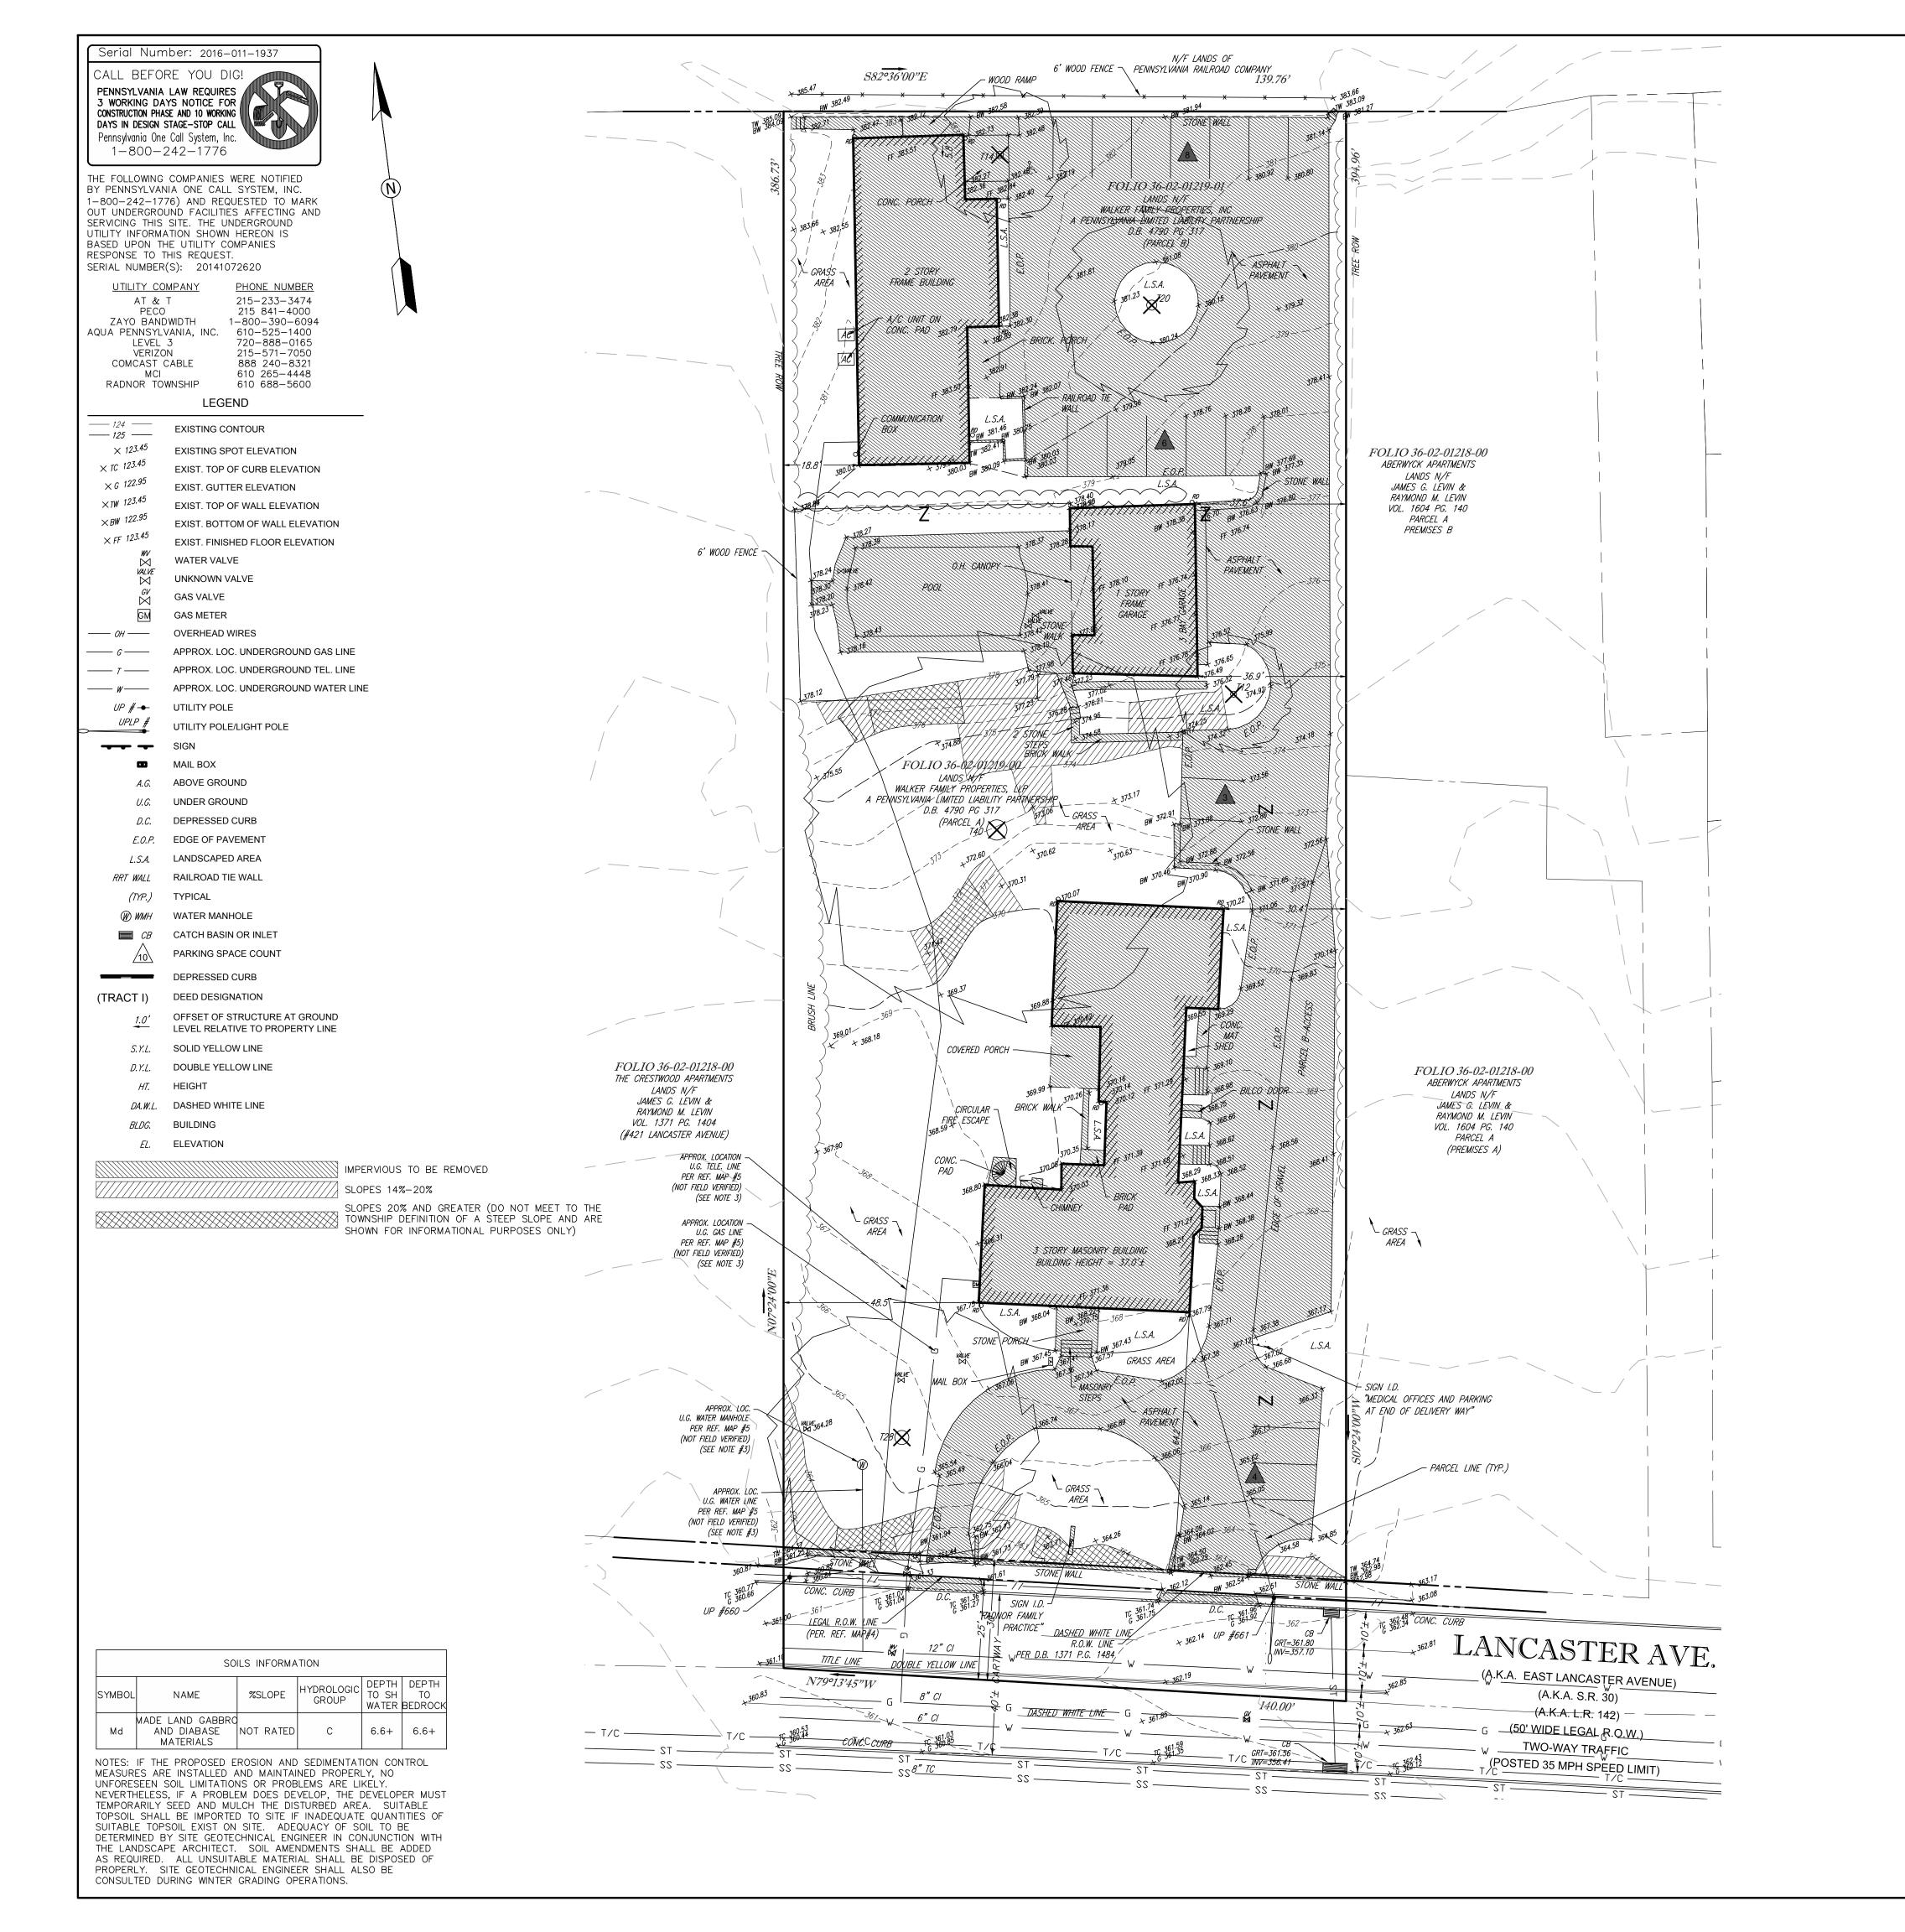

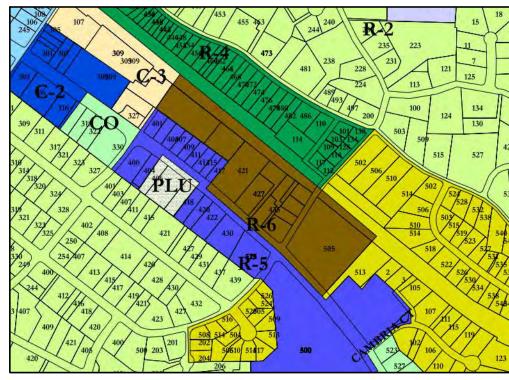

LOCATION MAP SCALE: 1" = 600'

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44 PAPER MILL ROAD

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WWW.YOHNENGINEERING.COM

1 02/22/16 PER TWP ENGS

PROFESSIONAL

CHRISTOPHER C. YOH

COMMENTS

DATE

PRELIMINARY PLANS

25,627 SF (46.9%)

EXISTING CONDITIONS / DEMOLITION PLAN

DATE: EQUITABLE OWNER/APPLICANT SCALE: 427 E. LANCASTER, LLC

ONE CALL NUMBER: DRAWN BY:

DECEMBER 31, 2015 '' = 20'2016-011-1937 CCY 15-031 PROJECT NUMBER:

OF

DELAWARE COUNTY

YOHN ENGINEERING, LLC 555 SECOND AVENUE, SUITE G-110 COLLEGEVILLE, PA 19426 610-489-4580





Serial Number: 2016-011-1937 CALL BEFORE YOU DIG! PENNSYLVANIA LAW REQUIRES
3 WORKING DAYS NOTICE FOR
CONSTRUCTION PHASE AND 10 WORKING DAYS IN DESIGN STAGE-STOP CALL **** Pennsylvania One Call System, Inc 1-800-242-1776

THE FOLLOWING COMPANIES WERE NOTIFIED BY PENNSYLVANIA ONE CALL SYSTEM, INC. 1-800-242-1776) AND REQUESTED TO MARK OUT UNDERGROUND FACILITIES AFFECTING AND SERVICING THIS SITE. THE UNDERGROUND UTILITY INFORMATION SHOWN HEREON IS BASED UPON THE UTILITY COMPANIES RESPONSE TO THIS REQUEST. SERIAL NUMBER(S): 20141072620

UTILITY COMPANY PHONE NUMBER 215-233-3474 AT & T 215 841-4000 ZAYO BANDWIDTH 1-800-390-6094 AQUA PENNSYLVANIA, INC. 610-525-1400 720-888-0165 215-571-7050 LEVEL 3 VERIZON 888 240-8321 COMCAST CABLE 610 265-4448 RADNOR TOWNSHIP 610 688-5600

LEGEND

	EXISTING CONTOUR
× 123.45	EXISTING SPOT ELEVATION
imes TC 123.45	EXIST. TOP OF CURB ELEVATION
\times G 122.95	EXIST. GUTTER ELEVATION
×TW 123.45	EXIST. TOP OF WALL ELEVATION
imesBW 122.95	EXIST. BOTTOM OF WALL ELEVATION
\times FF 123.45	EXIST. FINISHED FLOOR ELEVATION
w ⋈	WATER VALVE
VAL VE VAL VE	UNKNOWN VALVE
<i>GV</i> ⋈	GAS VALVE
GM	GAS METER
—— ОН ——	OVERHEAD WIRES
<i>G</i>	APPROX. LOC. UNDERGROUND GAS LINE
	APPROX. LOC. UNDERGROUND TEL. LINE
w	APPROX. LOC. UNDERGROUND WATER LINE
UP # -• -	UTILITY POLE
<i>UPLP </i>	UTILITY POLE/LIGHT POLE
	SIGN
•	MAIL BOX
A. G.	ABOVE GROUND
U.G.	UNDER GROUND
D.C.	DEPRESSED CURB
E.O.P.	EDGE OF PAVEMENT
L.S.A.	LANDSCAPED AREA
RRT WALL	RAILROAD TIE WALL
(TYP.)	TYPICAL
W WMH	WATER MANHOLE
■ CB	CATCH BASIN OR INLET
10	PARKING SPACE COUNT
	DEPRESSED CURB
(TRACT I)	DEED DESIGNATION
<u>1.0'</u>	OFFSET OF STRUCTURE AT GROUND LEVEL RELATIVE TO PROPERTY LINE
S.Y.L.	SOLID YELLOW LINE
D.Y.L.	DOUBLE YELLOW LINE
НТ.	HEIGHT
DA.W.L.	DASHED WHITE LINE


BLDG. BUILDING

EL. ELEVATION

SOILS INFORMATION					
SYMBOL	NAME	%SLOPE	HYDROLOGIC GROUP	10 SH	DEPTH TO BEDROCI
Md	MADE LAND GABBRO AND DIABASE MATERIALS	NOT RATED	С	6.6+	6.6+

NOTES: IF THE PROPOSED EROSION AND SEDIMENTATION CONTROL MEASURES ARE INSTALLED AND MAINTAINED PROPERLY, NO UNFORESEEN SOIL LIMITATIONS OR PROBLEMS ARE LIKELY. NEVERTHELESS, IF A PROBLEM DOES DEVELOP, THE DEVELOPER MUST TEMPORARILY SEED AND MULCH THE DISTURBED AREA. SUITABLE TOPSOIL SHALL BE IMPORTED TO SITE IF INADEQUATE QUANTITIES OF SUITABLE TOPSOIL EXIST ON SITE. ADEQUACY OF SOIL TO BE DETERMINED BY SITE GEOTECHNICAL ENGINEER IN CONJUNCTION WITH THE LANDSCAPE ARCHITECT. SOIL AMENDMENTS SHALL BE ADDED AS REQUIRED. ALL UNSUITABLE MATERIAL SHALL BE DISPOSED OF PROPERLY. SITE GEOTECHNICAL ENGINEER SHALL ALSO BE CONSULTED DURING WINTER GRADING OPERATIONS.



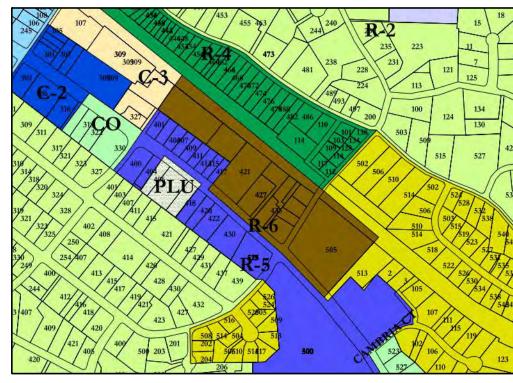

REFERENCE PLANS:
1. BOUNDARY AND TOPOGRAPHIC SURVEY PREPARED FOR RADNOR FAMILY

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6. THE EXISTENCE OF UNDERGROUND STORAGE TANKS, IF ANY, WAS NOT KNOWN AT THE TIME OF THE FIELD SURVEY. 7. ELEVATIONS ARE BASED UPON PA DOT BENCHMARK F101 REPUTED TO BE NAVD

1988 ELEVATION 343.57 8. UNDERGROUND STORM SEWER AND SANITARY SEWER PIPES ARE DRAWN GRAPHICALLY ON THIS SURVEY APPROXIMATE. UNDERGROUND STORM AND SANITARY PIPES SHOULD BE VERIFIED INDEPENDENTLY AS TO THEIR LOCATION. SIZE AND TYPE AND SHOULD BE CONSIDERED BY THE CONTRACTOR OR DESIGN

CONSULTANT PRIOR TO CONSTRUCTION. 9. THESE UNDERGROUND UTILITY COMPANIES DID NOT RESPOND TO PA ONE CALL REQUEST: ELECTRIC, GAS, AND TELEPHONE.

REFERENCE PLAN #1 REFERENCES: 1. MAP #015 OF THE OFFICIAL TAX MAPS OF THE RADNOR TOWNSHIP, DELAWARE

COUNTY, COMMONWEALTH OF PENNSYLVANIA. 2. MAP ENTITLED "NATIONAL FLOOD INSURANCE PROGRAM, FIRM, FLOOD INSURANCE RATE MAP, PENNSYLVANIA, DELAWARE COUNTY, PANEL 36 OF 250", COMMUNITY-PANEL NUMBER 420428 0036 F, MAP REVISED: NOV 18, 2009.

. MAP ENTITLED "NATIONAL FLOOD INSURANCE PROGRAM, FIRM, FLOOD INSURANCE RATE MAP, PENNSYLVANIA, DELAWARE COUNTY, PANEL 17 OF 250", COMMUNITY-PANEL NUMBER 420428 0017 F, MAP REVISED: NOV 18, 2009. 4. MAP ENTITLED "COMMONWEALTH OF PENNSYLVANIA, DEPARTMENT OF HIGHWAYS,

DRAWING FOR CONSTRUCTION AND CONDEMNATION OF RIGHT OF WAY ROUTE NO. 142 SECTION NO. 1 IN DELAWARE COUNTY; FROM STA. 2882+35 TO STA. 2891+10, LENGTH 875.0 FT 0.166 MI," SHEETS 1-3. 5. MAP ENTITLED "AS BUILT SURVEY MADE FOR J. GORDON AND LOIS T.

LONGENECKER, RADNOR TOWNSHIP, DELAWARE COUNTY, PENNSYLVANIA," PREPARED BY YERKS ASSOCIATES, INC.,. DATE MARCH 28, 2002.PLAN D-36-13 384.

RECORD OWNER: WALKER FAMILY PROPERTIES, LLP


427 EAST LANCASTER AVENUE WAYNE, PA 19087

EXISTING LOT DATA: TAX FOLIO NUMBER: 36-02-01219-00 36-13-384:000 TAX MAP NUMBER: 34,770 SF (0.7982 AC) SITE AREA: LOT AREA: 31,171 SF (0.7156 AC)

TAX FOLIO NUMBER: 36-02-01219-01 TAX MAP NUMBER: 36-13-384:001 19,852 SF (0.4557 AC) SITE AREA: LOT AREA: 19,252 SF (0.4420 AC)

EXISTING IMPERVIOUS COVERAGE: BUILDINGS & PORCHES WALKS

7,915 SF (14.5%) 726 SF PATIOS 969 SF ASPHALT DRIVES 14,168 SF GRAVEL DRIVES 1,506 SF OTHER 343 SF TOTAL 25,627 SF (46.9%)

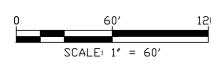

PROPOSED MULTI-FAMILY RESIDENTIAL DEVELOPMENT 427 EAST LANCASTER AVENUE, WAYNE, PA 19087 RADNOR TOWNSHIP DELAWARE COUNTY

PRELIMINARY PLANS

ÉQUITABLE OWNER/APPLICANT

427 E. LANCASTER, LLC

44 PAPER MILL ROAD

NEWTOWN SQUARE, PA 19073

YOHN ENGINEERING, LLC

555 SECOND AVENUE, SUITE G-110

COLLEGEVILLE, PA 19426

610-489-4580

WWW.YOHNENGINEERING.COM

VICINITY PLAN

SCALE: ONE CALL NUMBER: DRAWN BY:

PROJECT NUMBER:

DECEMBER 31, 2015

OF

' = 60'

CCY

15-031

2016-011-1937

- 1. Base information including topography, grading, utilities, building and existing
- vegetation location prepared by Yohn Engineering, LLC, February, 2016. 2. Location of existing trees on adjacent properties are approximate based upon field
- observations conducted by Glackin Thomas Panzak, Inc., January 2016. 3. This plan is for landscaping purposes only.
- 4. The Landscape Architect's seal applies only to the landscape portion of this plan. 5. See Sheet LP-2 for Planting Details and Planting and Maintenance Notes.
- 6. All plant material is to be field adjusted as necessary to address existing site conditions, proposed unit landscaping, and to ensure that clear sight triangles and clear sight lines are maintained.
- 7. Proposed shade trees shall not be planted over the top of any sewer or water laterals, mains or services. Sewer and water laterals, mains and services are shown on Landscape Plans for reference only. See engineer's plans for location of all utilities.
- 8. Shade and evergreen trees shall be planted fifteen (15) feet from overhead utility lines or light standards. Utilities are shown on Landscape Plans for reference only. See
- engineer's plans for location of all utilities. 9. No planting shall be installed closer than five (5) feet to any property line.
- 10. All plantings shall be permanently maintained.
- 11. All trees shall be pruned as necessary to maintain required light levels.
- 12. Final location of all plant material proposed for adjacent properties shall be determined in the field in order to address existing conditions.

LEGEND:

EXISTING VEGETATION

PROPOSED DECIDUOUS TREE

PROPOSED ORNAMENTAL TREE

PROPOSED EVERGREEN TREE

PROPOSED SHRUBS

PROPOSED GROUND COVERS / PERENNIALS

EXISTING TREE TO BE REMOVED

SANDWICH BOARD FENCE

LANDSCAPE COMPLIANCE:


SECTION	CATEGORY		REQU	JIRED			PROV	/IDED	
		Shade Trees	Flowering Trees	Evergreen Trees	Shrubs	Shade Trees	Flowering Trees	Evergreen Trees	Shrubs
255-29.B.	PARKING FACILITY LANDSCAPE (1) 2.5" cal. per 5 Spaces of Single Bay Parking	2				2			
255-38.B.	STREET TREES (1) 2.5" cal. tree spaced at 30' o.c. Applied to 115 LF*	4				4			
255-42	BUFFER SCREENS CLASS B - Lancaster Ave. (Arterial Road Classification) Option of (1) Evergreen Tree per 15 LF and (1) Evergreen Shrub per 8 LF applied to 115 LF*			8	15			8	15
	TOTALS:	6		8	15	6		8	15

*Linear foot measurement does not include access driveway width.

PLANT LIST:

KEY	QTY	BOTANICAL NAME	COMMON NAME	SIZE	REMARKS
DECID	UOUS TR	EES			
AML	3	Amelanchier laevis	Allegheny Serviceberry	2"-2.5" cal.	B&B
BENH	2	Betula nigra 'Heritage'	Heritage River Birch	12'-14' ht.	B&B , Multi-st
CEJ	4	Cercidiphyllum japonicum	Katsura Tree	2"-2.5" cal.	B&B
COFC	4	Cornus florida 'Cherokee Princess'	Cherokee Princess Dogwood	2"-2.5" cal.	B&B
ZESV	4	Zelkova serrata 'Village Green'	Village Green Zelkova	2"-2.5" cal.	B&B
EVERG	REEN TR	REES			
ILAD	3	Ilex aquipernyi 'Dragon Lady'	Dragon Lady Holly	8'-10' ht.	Cont.
THGG	15	Thuja plicata 'Green Giant'	Green Giant Arborvitae	8'-10' ht.	B&B
SHRUB					
BUGM	32	Buxus x 'Green Mountain'	Green Mountain Boxwood	24"-30" ht.	Cont.
HYBW	7	Hydrangea 'Blue Wave"	Blue Wave Hydrangea	24"-30" ht.	Cont.
HYQR	15	Hydrangea quercifolia 'Ruby Slippers'	Ruby Slippers Oakleaf Hydrangea	24"-30" ht.	Cont.
ILCH	33	Ilex crenata 'Helleri'	Helleri Japanese Holly	24"-30" ht.	Cont.
PRLO	5	Prunus laurocerasus 'Otto Luyken'	Otto Luyken Cherry Laurel	24"-30" ht.	Cont.
PRLS	12	Prunus laurocerasus 'Schipkaensis'	Skip Laurel	24"-30" ht.	Cont.
RORK	11	Rosa 'Red Knockout'	Red Knockout Rose	24"-30" ht.	Cont.
SPJL	9	Spiraea japonica 'Little Princess'	Little Princess Spiraea	24"-30" ht.	Cont.
SPJN	27	Spiraea japonica 'Neon Flash'	Neon Flash Spirea	24"-30" ht.	Cont.
VIDB	23	Viburnum dentatum 'Blue Muffin'	Blue Muffin Arrowwood Viburnum	24'-30' ht.	Cont.
VIP	25	Viburnum x pragense	Prague Viburnum	24"-30" ht.	Cont.
PEREN	NIALS &	GROUNDCOVERS			
CAPS	259	Carex pensylvancia	Pennsylvania Sedge	2 qt.	Cont. 12" o.c.
ECPW	15	Echinacea purpurea 'White Swan'	White Coneflower	1 gal.	Cont. 18" o.c.
LIMV	90	Liriope muscari 'Variegata'	Variegated Lilyturf	2 qt.	Cont. 12" o.c.
PAVH	60	Panicum virgatum 'Heavy Metal'	Heavy Metal Switch Grass	3 gal.	Cont.
VINES					
HYAP	1	Hydrangea anomala v. petiolaris	Climbing Hydrangea	3 gal.	Cont., On Trel

1. Where there is a discrepancy between the plant list and plan, the plan shall prevail.

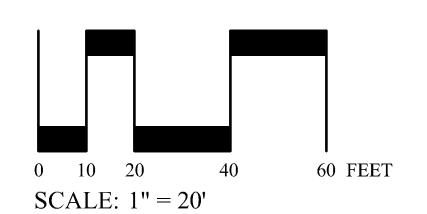




GLACKIN **THOMAS PANZAK** LAND PLANNING LANDSCAPE **ARCHITECTURE**

Glackin Thomas Panzak, Inc.

Paoli Executive Green 41 Leopard Road Paoli, Pennsylvania 19301 610.408.901 Fax: 610.408.9477 E-mail: plans@glackinplan.com

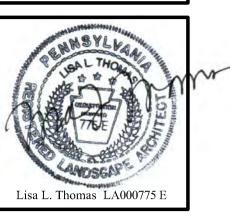

PROJECT #: 16-001 DATE: 2/22/16 (sa) REV.:

SHEET:

BE REJECTED.

DECIDUOUS TREE DETAIL

NTS

NOTE:
1. FLOOD PLANTING PIT WITH WATER TWICE WITHIN 24 HOURS OF PLANTING.

3.TREES THAT DO NOT DISPLAY THE TYPICAL CHARACTERISTICS FOR THEIR SPECIES SHALL

GUY SPACING DIAGRAM - APPLY ANTI-DESICCANT FOR FALL PLANTINGS. - PRUNE ONLY BROKEN OR DEAD BRANCHES. THREE (3) FLAT STRAPS OR WEBBING AT 120° AROUND TREE. TENSION OF STRAPS NOT TAUT TO ALLOW FOR SMALL AMOUNT OF TRUNK MOVEMENT. REMOVE AFTER ONE YEAR. REMOVE EXCESS SOIL FROM TOP OF ROOT BALL AND DETERMINE DEPTH OF ROOTBALL BEFORE DIGGING PIT OF PLACING TREE IN PIT. AFTER PLANTING, ROOT COLLAR SHALL BE SLIGHTLY HIGHER THAN THE ADJACENT FINISH GRADE AND TOPMOST MAJOR ROOTS SHALL BE I" BELOW FINISH GRADE. THREE (3) INCHES OF HARDWOOD BARK MULCH OR APPROVED EQUAL. DO NOT MOUND MULCH AGAINST TREE TRUNK. PLANT SAUCER - 3' \times 2" \times 2" HARDWOOD STAKE 120° APART. DRIVEN FLUSH TO FINISH GRADE. THREE (3) PER TREE. BACK FILL USING EXCAVATED TOPSOIL. MATER THOROUGHLY TO ELIMINATE AIR POCKETS. DO NOT COMPACT. REMOVE BURLAP FROM THE TOP 1/3 OF ROOT BALL. REMOVE ALL NON-ORGANIC MATERIAL FROM ENTIRE BALL. FOR WIRE 2.5 TIMES BASKETS, CUT TOP 2/3 AND REMOVE FROM PIT AFTER POSITIONED AND READY FOR ROOTBALL DIAMETER

2 EVERGREEN TREE DETAIL

NTS

1. FLOOD PLANTING PIT WITH WATER TWICE WITHIN 24 HOURS OF PLANTING.

N 1 S
NOTE:
1. FLOOD PLANTING PIT WITH WATER TWICE WITHIN 24 HOURS OF PLANTING.

PROPOSED GROUNDCOVER/ PERENNIAL

2" OF MULCH

2" OF TOPSOIL


SUBGRADE

NOTE:
PLANTS MUST BE PLANTED IN BEDDING
MIX OR TOPSOIL, NOT MULCH.

PLANTING DETAIL

NOTE:

NOTE:
PLANTS MUST BE PLANTED IN BEDDING MIX OR TOPSOIL NOT MULCH

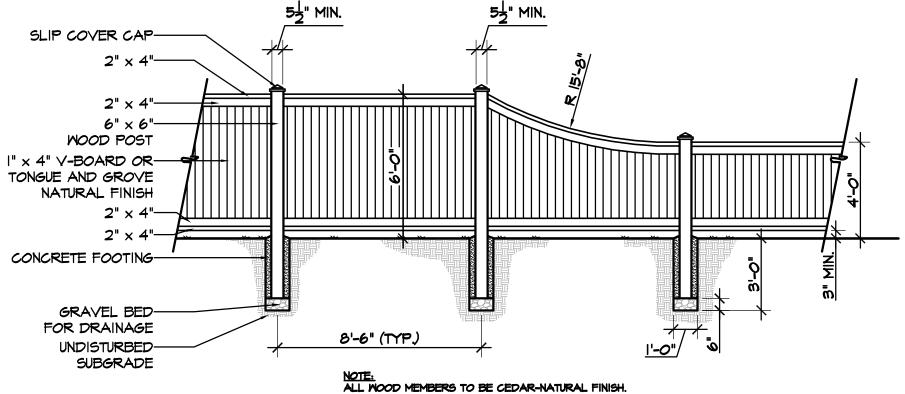

5 SANDWICH BOARD FENCE

PLANTING NOTES:

FOR EVERGREEN SHRUBS APPLY ANTI-DESICCANT TO ENTIRE PLANT

AT RECOMMENDED RATES AND

- PRUNE ONLY BROKEN OR DEAD BRANCHES.

REMOVE EXCESS SOIL FROM TOP OF ROOT BALL.

BACK FILL USING EXCAVATED TOPSOIL. WATER THOROUGHLY TO ELIMINATE AIR POCKETS. DO NOT

- BALL AND BURLAPPED SHRUBS
REMOVE BURLAP FROM THE TOP 1/3 OF
ROOT BALL. REMOVE ALL
NON-ORGANIC MATERIAL FROM ENTIRE

CONTAINER SHRUBS
REMOVE CONTAINER COMPLETELY.
MAKE 3 TO 4 CUTS THE LENGTH OF THE

SLIGHTLY HIGHER THAN THE ADJACENT FINISH GRADE.

- THREE INCHES (3") OF HARDWOOD MULCH OR APPROVED EQUAL. DO NOT MOUND MULCH AGAINST SHRUB.

PLANT SAUCER

2.5 TIMES

ROOTBALL DIAMETER

SHRUB DETAIL


- 1. The contractor shall furnish and plant all plants shown on the drawings, as specified, and in quantities indicated on the plant list.
- 2. All plants shall be nursery grown and freshly dug.
- 3. All plants shall be in accordance with The American Standard for Nursery Stock, latest edition.
- 4. All plants shall be hardy under climatic conditions similar to those in the locality of the project.
- 5. Fall Digging Hazard: Any species listed below, if included on the plant list, must not be dug in the fall (October through December) because of risk to the tree's survival. Special exceptions may be granted if the owner is notified in writing and an extended warranty on these plants is agreed upon prior to digging. The following varieties should not be dug in fall: Betula, Carpinus, Celtis, Cercidiphyllum, Crataegus, Cryptomeria, Fagus, Halesia, Ilex (tree form varieties), Liquidambar, Liriodendron, Nyssa, Ostrya, Prunus, Pyrus, Quercus (except Quercus palustris), Salix weeping varieties, and Tilia tomentosa. Digging for Malus and Zelkova varieties should be avoided in fall only when in leaf.
- 6. All plants shall be typical of their species or variety and shall have a normal habit or growth. They shall be sound, healthy and vigorous, well branched and densely foliated when in leaf. They shall be certified by appropriate State and Federal authorities to be free of disease and insect pests, eggs or larvae. They shall have healthy, well-developed root systems.
- 7. Trees with central leader broken or dead shall be rejected
- 8. Plants that do not display typical characteristics for their species shall be rejected.
 9. Substitutions: When plants of a specified kind or size are not available within a reasonable distance, substitutions may be made upon written request by the contractor, if approved by the owner and/or municipal authority.
- 10. Measurement: Dimensions of trees and shrubs shall conform to The American Standard for Nursery Stock, latest edition.
- 11. Size: All plants shall conform to the measurement specified on the plant list, unless authorized in writing by the Township landscape architect and the owner.
- 12. Balled and burlapped plants shall be dug with firm natural balls of earth, of diameter and depth to include most of the fibrous roots. Container grown stock shall have been grown in a container long enough for the root system to have developed sufficiently to hold its soil together firm and whole. No plants shall be loose in the container.
- together firm and whole. No plants shall be loose in the container.

 13. Plants with poor quality root balls or root balls that have been cracked or damaged shall be
- 14. Root balls of all plants shall be adequately protected at all times from sun and drying winds
- 15. Conditions detrimental to plants: The contractor shall notify the project representative in writing of all soil or drainage conditions which the contractor considers detrimental to the growth of plants. The contractor shall state the conditions and submit a proposal for correcting the conditions, including any change in cost, for review and acceptance by the
- 16. The owner or the owner's representative shall be notified prior to beginning planting operations
- 17. All planting shall be at the locations indicated on the drawings. The contractor shall be responsible for planting at the correct grades, alignment, and to the indicated layout of the planting beds.
- 18. Layout of planting: The contractor shall lay out with identifiable stakes the location of all planting beds as indicated on drawing. The layout of planting shall be approved by the project representative prior to any excavation of plant pits or plant beds.
- 19. Minor adjustments to plant locations may be necessary due to field conditions and final grading. The contractor shall notify the owner if major adjustments are required.
- 20. Planting soil shall be excavated native soil from the planting pit. Planting soil shall be thoroughly mixed, with all rocks, clods and roots removed.
- 21. Plants with broken root balls or excessive damage to the crown shall be replaced prior to planting.
- 22. If needed, trees shall be staked and guyed according to accepted industry practice.
- 23. Each tree and shrub shall be pruned in accordance with The American Nursery and Landscape Association Standards to preserve the natural character of the plant. All dead wood or suckers and all broken or badly bruised branches shall be removed.
- 24. Mulch: Immediately after planting operations are completed, all trees and shrub planting pits shall be covered with a 3" (three inch) layer of double shredded hardwood bark mulch, or other material approved by the owner or the owner's representative. A granular pre-emergent weed control shall be spread prior to mulching. The limit of this mulch for deciduous trees and single evergreen trees shall be the area of the pit. For shrub and perennial beds and for evergreen tree clusters, a continuous, mulched bed shall be created.
- 25. Trees in leaf, including evergreens, when planted shall be treated with anti-desiccant such as Wilt-Pruf® if planted during the months of June through September, November, and December.
- 26. Weed control: All planting areas shall be free from weeds prior to the beginning of planting operation. Contact herbicide sprays should only be used as required and all manufacturer's specifications followed.
- 27. Guarantee: All plant material shall be guaranteed by the contractor for twenty four (24) months from the date of installation. The owner shall be responsible for maintenance unless otherwise agreed with contractor. It shall be the contractor's responsibility to monitor the project during the guarantee and notify the owner if problems develop with the plant material. Any material that is 25 % dead or more shall be considered dead and must be replaced at no charge. A tree shall be considered dead when the main leader has died back, or there is 25% of the crown dead.
- 28. All debris resulting from landscape contracting operations shall be cleaned up and removed from the site on a weekly basis.
- 29. Watering: Landscape contractor is responsible for watering sufficiently at the time of planting and until the job is completed, accepted and turned over to the owner.
- 30. All plant material shall be installed in accordance with the planting practices stated in chapter 5 of <u>Pirone's Tree Maintenance</u> by: J. Hartman, T. Pirone and M. Sall (seventh or most recent edition)

GLACKIN
THOMAS
PANZAK
LAND PLANNING
LAND SCAPE
ARCHITECTURE

☐ Glackin Thomas Panzak, Inc

Paoli Executive Green Suite 300 Suite 300 41 Leopard Road Paoli, Pennsylvania 1930 610.408.901 Fax: 610.408.9477 E-mail: plans@glackinplan.com

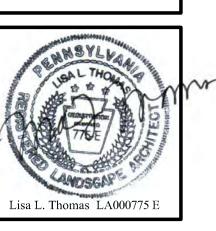

ES & DETAILS
THUE

127 Lancaster Avenusor township, delaware county, pennsylv

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ANDSC


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PRELIMINAR

PROJECT #: 16-001 DATE: 2/22/16 (sa) REV.:

SHEET:


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ISSUE DATE:

503 WEST LANCASTER AVENUE, WAYNE, PA. 19087 PHONE (610) 687-0800 FAX (610) 687-8717

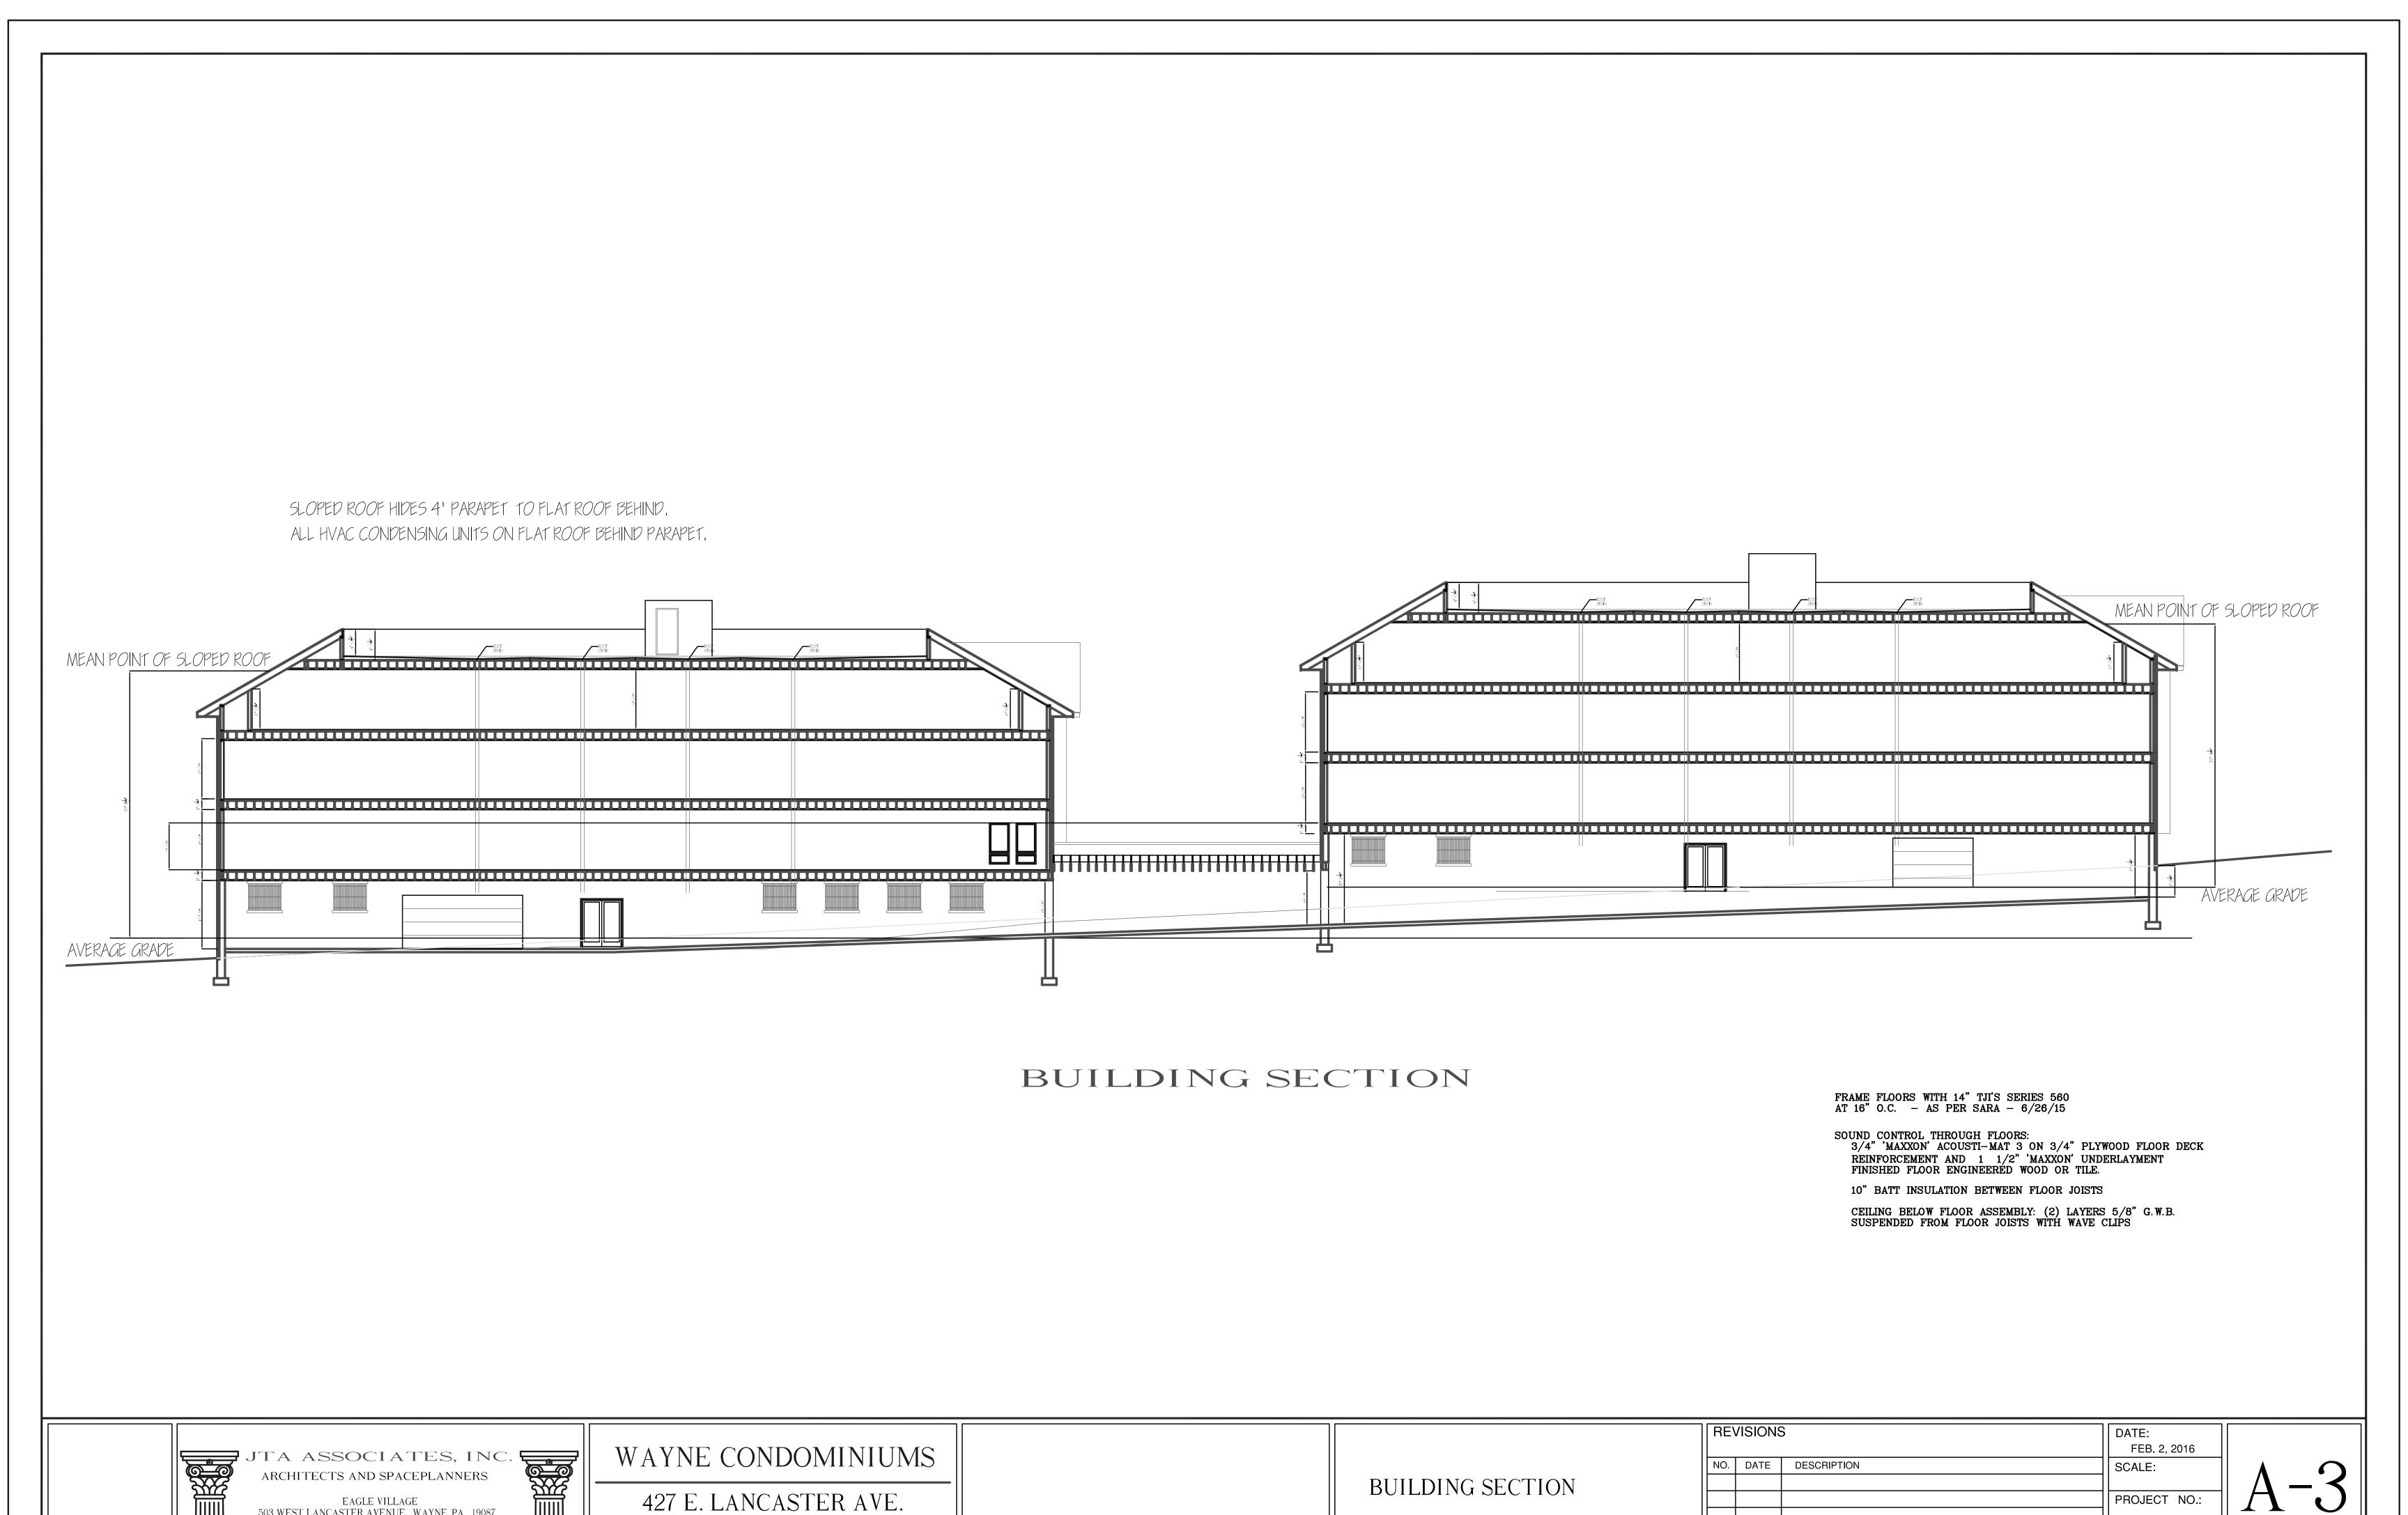WAYNE, PA 19087




HIGH WATER TABLE	
SITE IS TO BE USED FOR CONSTRUCTION, DEWATER EXCAVATIONS THROUGH A PUMPED WATER FILTER BAG AS NECESSARY, AVOID PONDING DURING CONSTRI LOSE ALL EXCAVATIONS AS SOON AS PRACTICAL; ENSURE ALL INSTALLED PIPE IS WATERTIGHT.	JCTION;
NATURALLY ACIDIC	
ONTRACTOR TO WRAP ALL METAL-BASED PIPING WITH PLASTIC LINER. PLASTIC LINER SHALL BE APPROVED BY THE GEOTECHNICAL ENGINEER PRIOR TO INSTALI	ATION.
EROSION HAZARD	
HE CONTRACTOR SHALL FOLLOW THE EROSION AND SEDIMENT CONTROL SEQUENCE OF CONSTRUCTION AND PLANS. THE EROSION CONTROL MEASURES SHALL SPECTED AFTER EVERY RUNOFF EVENT AND ON A WEEKLY BASIS. IMMEDIATELY AFTER EVERY RUNOFF EVENT THE EROSION AND SEDIMENTATION FACILITIES A EASURES WILL BE CLEANED, REPAIRED, AND REPLACED AS NEEDED. WASHED-OUT AREAS WILL BE RE-GRADED AND RE-SEEDED. SILT FENCES WILL BE INSPECT ESTORED TO AN UPRIGHT AND EFFECTIVE POSITION AFTER EVERY RUNOFF EVENT OR WHEN THEY ARE OBSERVED TO BE IN NEED OF MAINTENANCE.	ND
SOLUTION CAVERNS IN UNDERLYING BEDROCK	
THE SITE IS TO BE USED FOR BUILDING, AND FOUNDATIONS ARE PROPOSED THEN THE SITE SHALL BE EVALUATED BY A GEOTECHNICAL ENGINEER TO DETERMII DLUTION CAVERNS ARE PRESENT. CONSULT THE GEOTECHNICAL ENGINEER AND REPAIR ACCORDING TO APPROVED DETAILS.	1E IF
EWATER EXCAVATIONS THROUGH A PUMPED WATER FILTER BAG AS NECESSARY.	
OID PONDING DURING CONSTRUCTION; CLOSE ALL EXCAVATIONS AS SOON AS PRACTICAL; ENSURE ALL INSTALLED PIPE IS WATERTIGHT	
SINK HOLE OR CLOSED DEPRESSION	

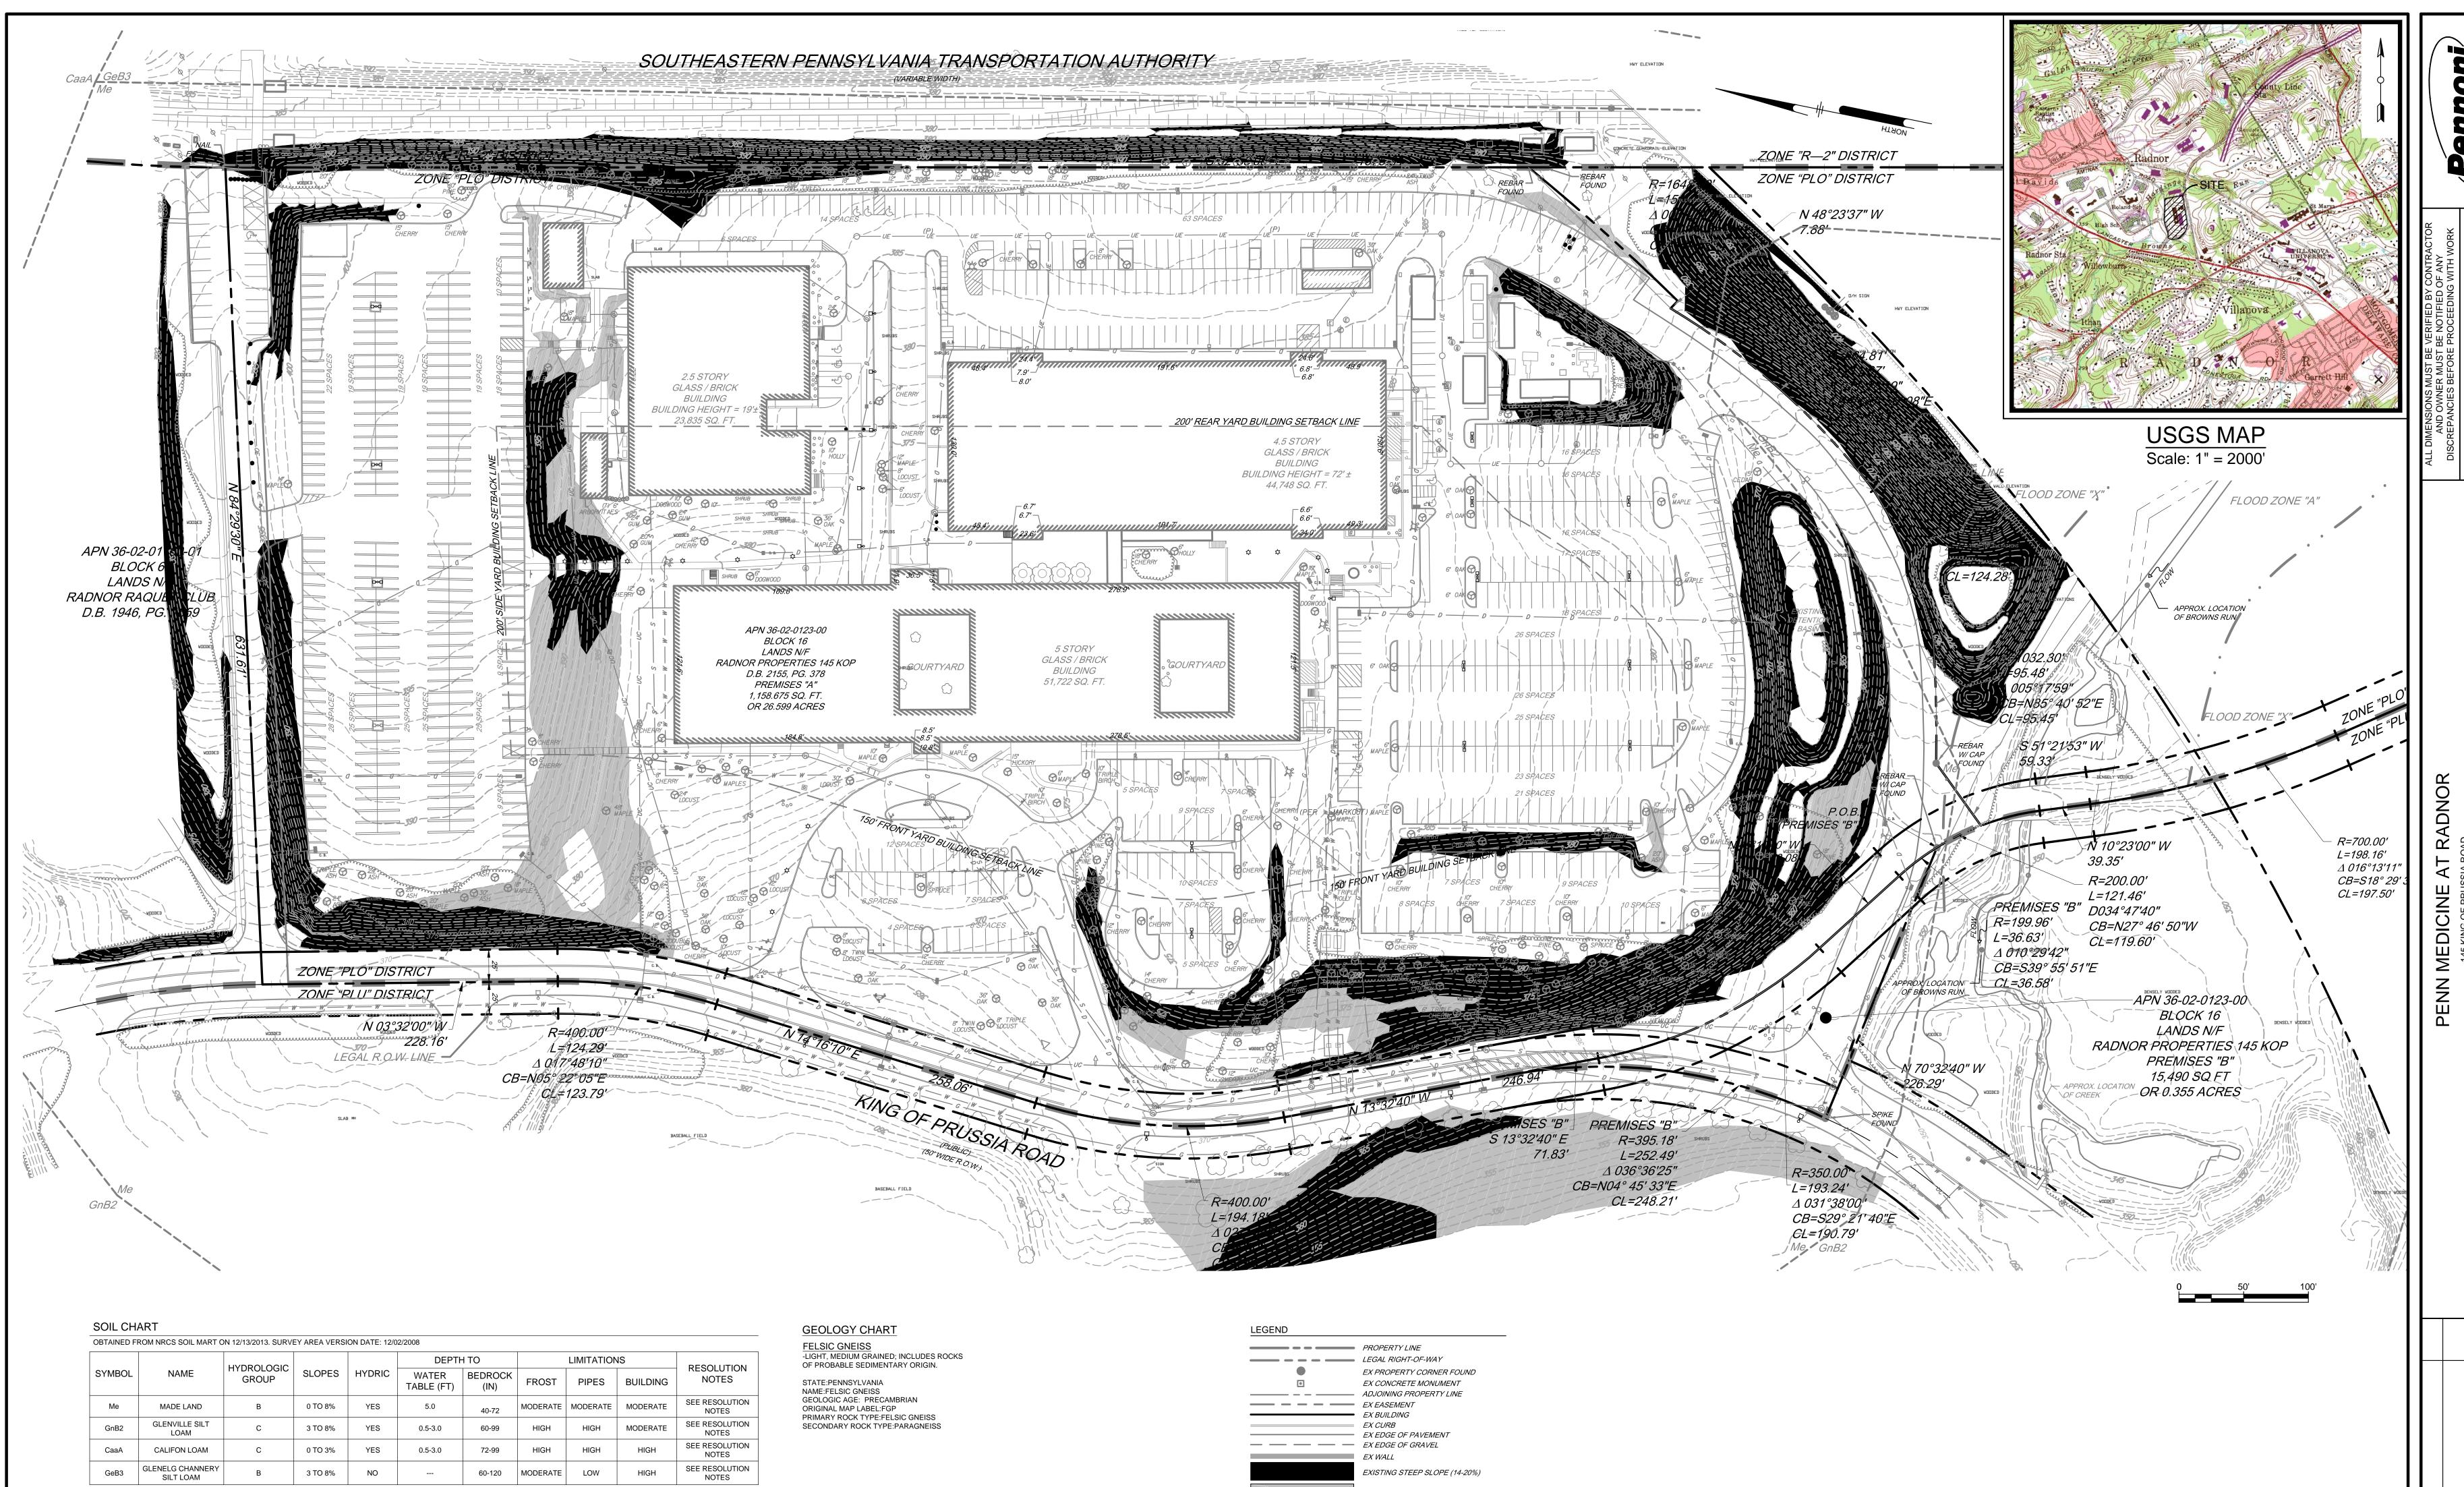THE CONTRACTOR SHALL CONTACT A GEOTECHNICAL ENGINEER TO ANALYZE THE SINK HOLE AREA. THE CONTRACTOR SHALL FOLLOW THE RECOMMENDATIONS OF THE GEOTECHNICAL ENGINEER FOR REMEDIATION REQUIREMENTS. SUITABLE FILL MATERIAL FOR ALL PIPING SHALL BE USED PER RECOMMENDATIONS OF A GEO-TECHNICAL ENGINEER.

LEGEND	BRODERTY I WE
	PROPERTY LINELEGAL RIGHT-OF-WAY
	EX PROPERTY CORNER FOUND
	EX CONCRETE MONUMENT
	- ADJOINING PROPERTY LINE
	= EX EASEMENT
	■ EX BUILDING
	= EX CURB = EX EDGE OF PAVEMENT
	= EX EDGE OF GRAVEL
	EX WALL
	EXISTING STEEP SLOPE (14-20%)
	EXISTING VERY STEEP SLOPE (>20%
	- EX FENCE LINE
	EX SIGN
*()000	EX LANDSCAPING
	EX TREE ROW
 361	EX MINOR CONTOUR
	EX MAJOR CONTOUR
D D	EX STORM SEWER LINES
\bigcirc	EX UTILITY MANHOLE
	EX STORM SEWER INLET
	EX STORMWATER MANHOLE
OEOE	EX OVERHEAD ELECTRICAL LINES
	- EX ELECTRICAL LINES EX UTILITY POLE
w w	- EX WATER LINES
***	EX FIRE HYDRANT
	EX WATER VALVE
ss	EX SANITARY SEWER LINES
S	EX SANITARY MANHOLE
G G	EX NATURAL GAS LINES
	SOILS BOUNDARY LINES
WaC	SOILS TEXT
FLOW	EX STREAM FLOW

MEDICINE 145 KING OF PRIES ALL DOCUMENTS PREPARED BY PENNONI ASSOCIATES ARE INSTRUMENTS OF SERVICE IN RESPECT OF THE PROJECT. THEY ARE NOT INTENDED OR REPRESENTED TO BE SUITABLE FOR REUSE BY OWNER OR OTHERS ON THE EXTENSIONS OF THE PROJECT OR ON ANY OTHER PROJECT. ANY REUSE WITHOUT WRITTEN VERIFICATION OR ADAPTATION BY PENNONI ASSOCIATES FOR THE SPECIFIC PURPOSE INTENDED WILL BE AT OWNERS SOLE RISK AND WITHOUT LIABILITY OR LEGAL EXPOSURE TO PENNONI ASSOCIATE; AND OWNER SHALL INDENANCY AND COMMENT SHALL INDENANCY ASSOCIATE. INDEMNIFY AND HOLD HARMLESS PENNONI ASSOCIATES FROM ALL CLAIMS, DAMAGES, LOSSES AND EXPENSES ARISING OUT OF OR RESULTING THEREFROM. UPHS1504 DRAWING SCALE DRAWN BY APPROVED BY

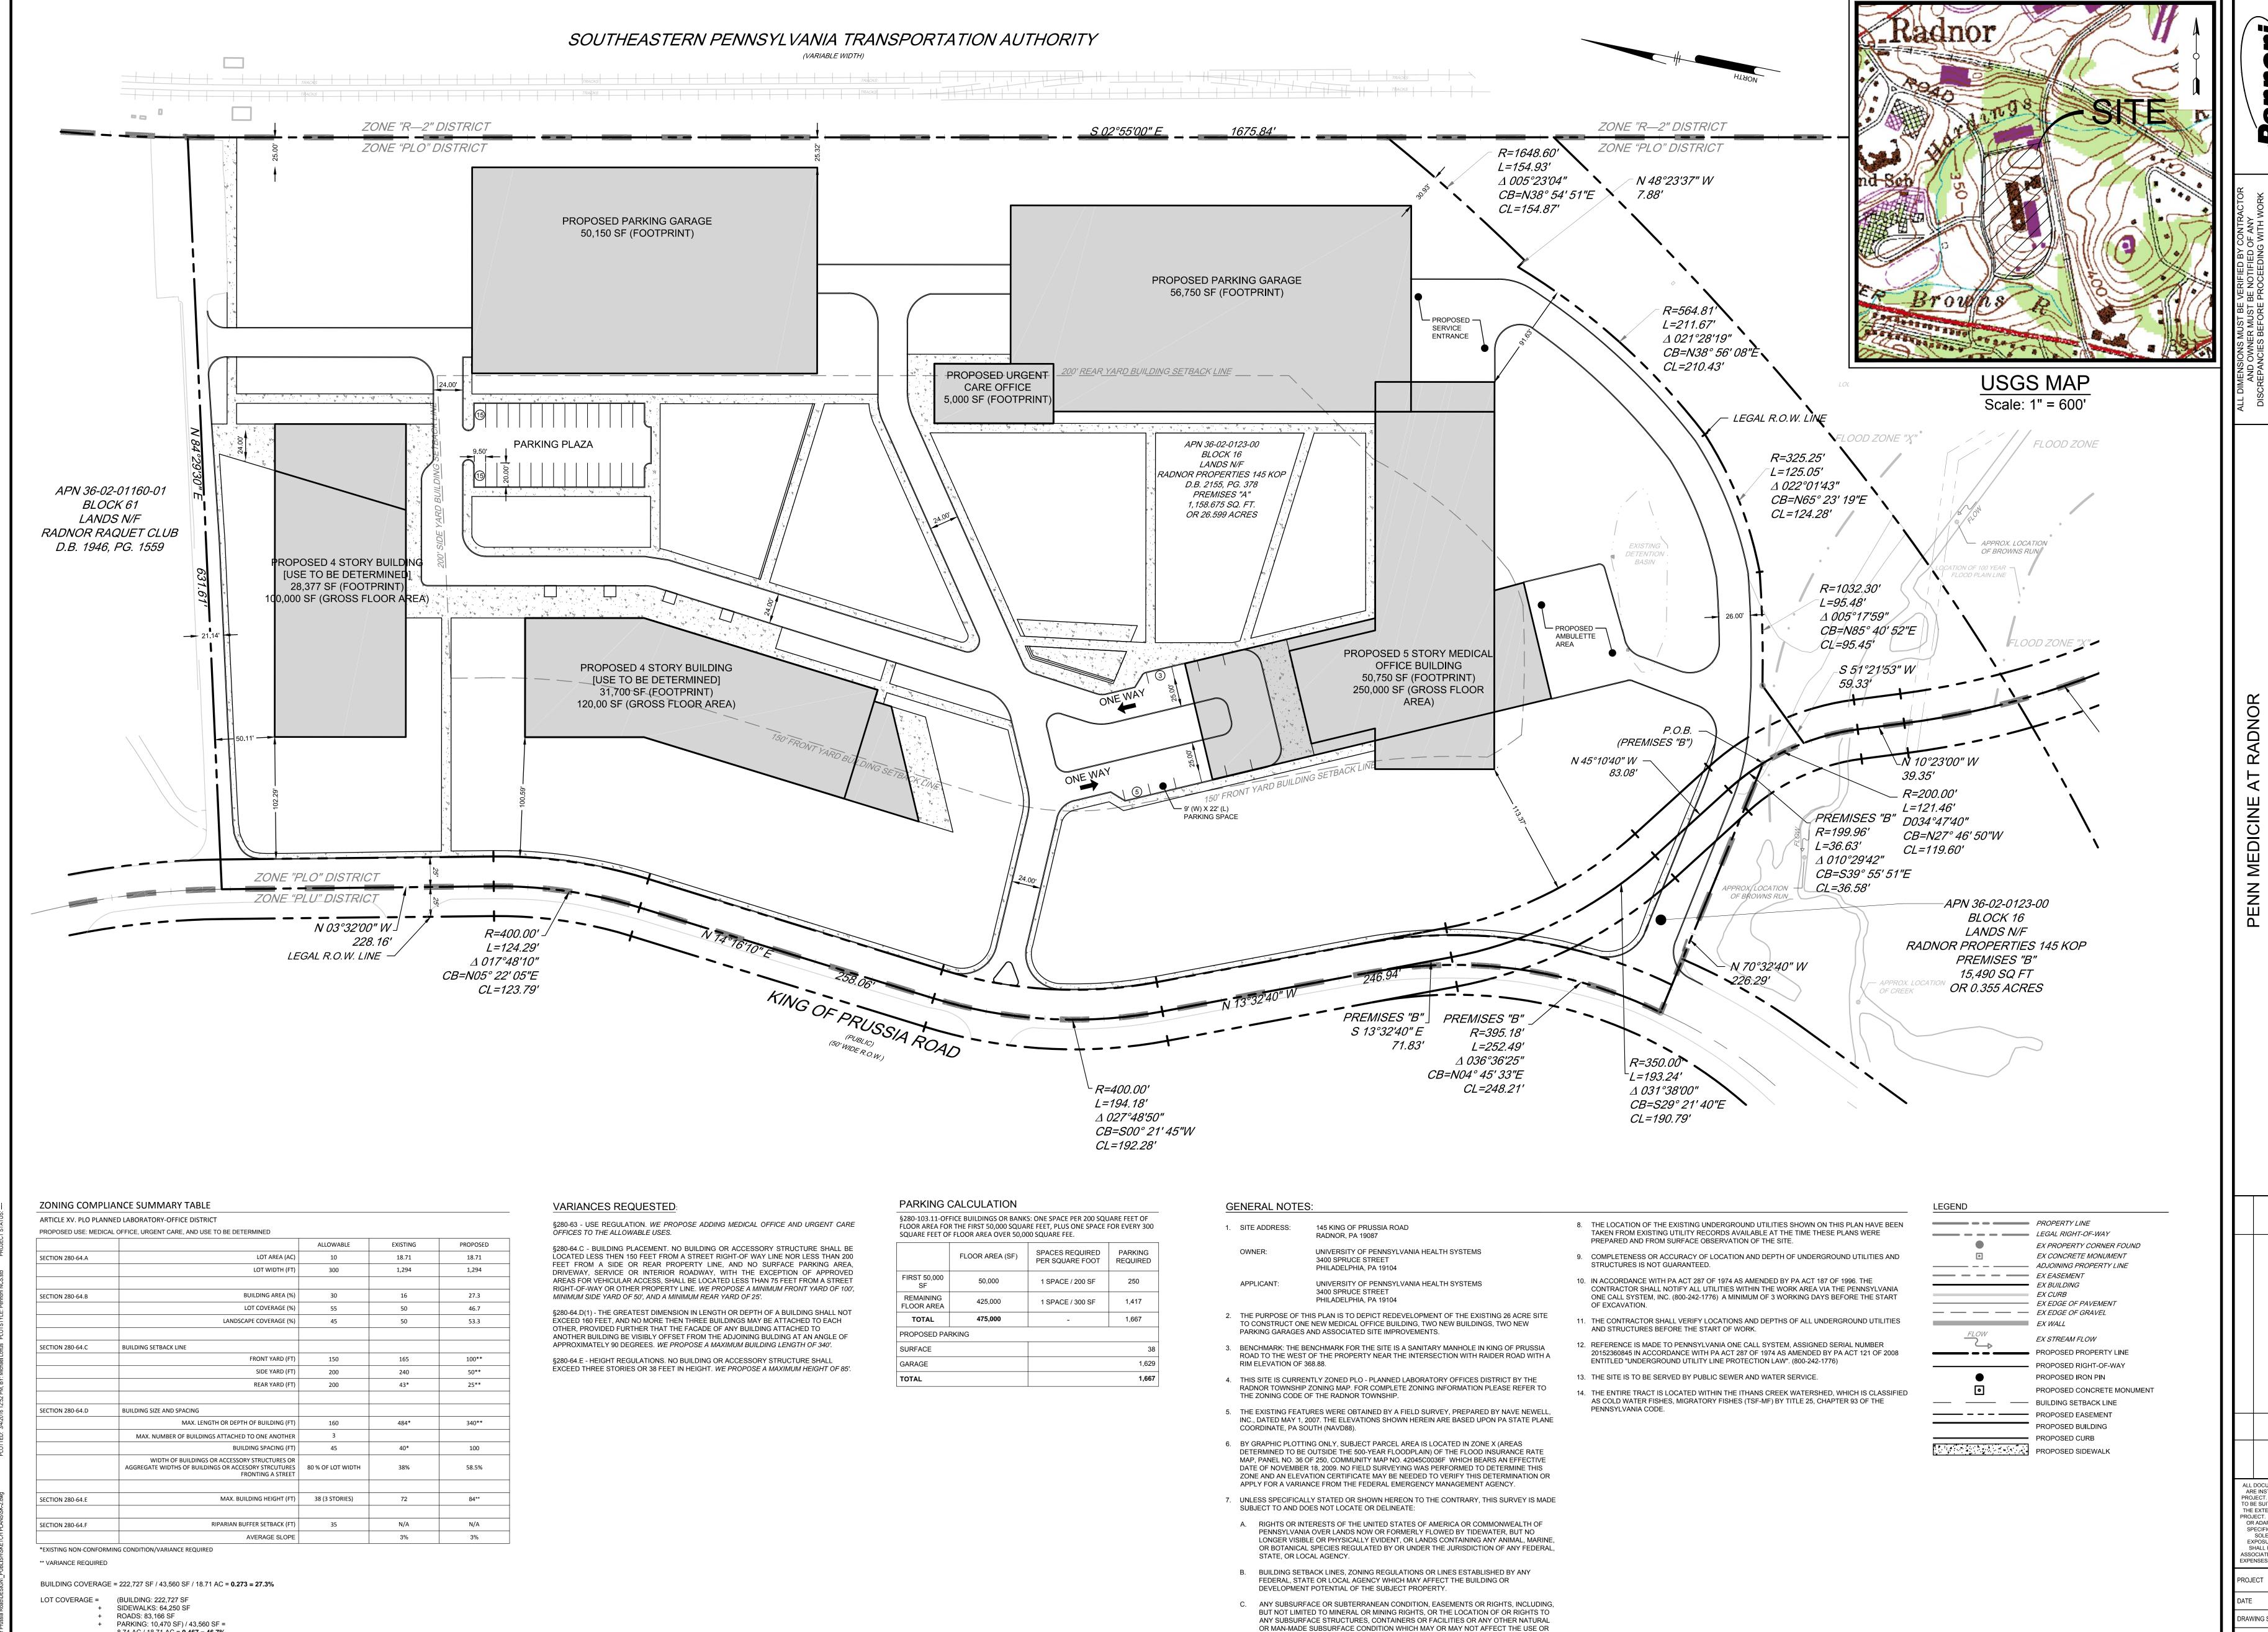

DEVELOPMENT POTENTIAL OF THE SUBJECT PROPERTY.

8.74 AC / 18.71 AC = **0.467 = 46.7**%

MAXIMUM BUILDING WIDTH ALONG FRONTAGE = 757' / 1,294' = 0.585 = 58.5%

LANDSCAPE COVERAGE = 1-0.467 = **0.533 = 53.3%**

ALL DOCUMENTS PREPARED BY PENNONI ASSOCIATE ARE INSTRUMENTS OF SERVICE IN RESPECT OF THE PROJECT. THEY ARE NOT INTENDED OR REPRESENTED TO BE SUITABLE FOR REUSE BY OWNER OR OTHERS ON THE EXTENSIONS OF THE PROJECT OR ON ANY OTHER PROJECT. ANY REUSE WITHOUT WRITTEN VERIFICATION OR ADAPTATION BY PENNONI ASSOCIATES FOR THE SPECIFIC PURPOSE INTENDED WILL BE AT OWNERS SOLE RISK AND WITHOUT LIABILITY OR LEGAL EXPOSURE TO PENNONI ASSOCIATES; AND OWNER SHALL INDEMNIEY AND HOLD HARMLESS PENNONI ASSOCIATES FROM ALL CLAIMS, DAMAGES, LOSSES ANI EXPENSES ARISING OUT OF OR RESULTING THEREFROM **UPHS1504** RAWING SCALE DRAWN BY APPROVED BY NOT FOR CONSTRUCTION